

ORANGE COUNTY PUBLIC WORKS

AS BUILT

CORRECTION BY: Webster Labrador
CONTRACT NO.: ER08960
DATE: 11/23/2010

Contractor: West Coast Structures, Inc.

Completion Date: November 10, 2010

SANTA ANA, CALIFORNIA

JESS CARBAJAL, DIRECTOR

PLANS FOR CONSTRUCTION OF

BROWNING AVENUE SIDEWALK GAP CLOSURE PROJECT

WESTSIDE OF BROWNING AVENUE BETWEEN RIVER FORD ROAD AND IRVINE BOULEVARD

W.O. NO. ER08960 FEBRUARY 2010


FUNDED BY: OCTA TRANSPORTATION DEVELOPMENT ACT

AND COUNTY OF ORANGE

MAINTAINED BY: COUNTY OF ORANGE


CITY OF TUSTIN WILL MAINTAIN CATCH BASIN BMP

(SHEET 7) PER WQMP NO. 08-07

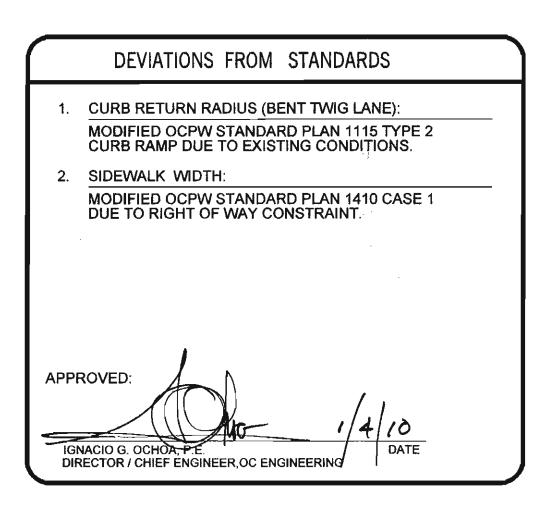

UNDERGROUND SERVICE ALERT

CALL 1-800-422-4133 TWO (2)
WORKING DAYS PRIOR TO EXCAVATION

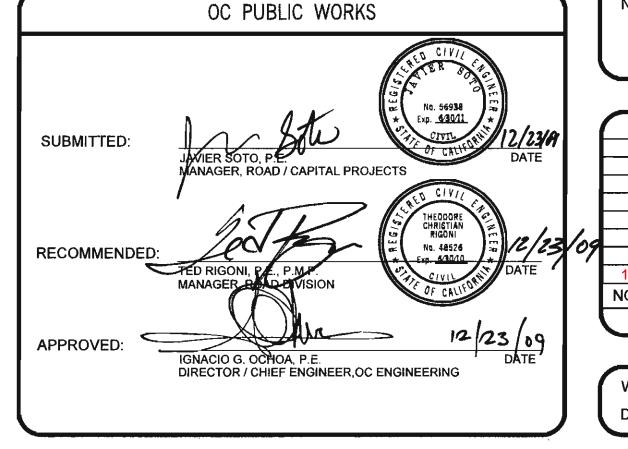

INDEX OF SHEETS

DESCRIPTION

PLAN AND PROFILE STA 11+00 TO 14+00

TITLE SHEET

2 TYPICAL CROSS SECTION

PLAN AND PROFILE STA 0+00 TO 4+00

PLAN AND PROFILE STA 4+00 TO 7+5

5 PLAN AND PROFILE STA 7+50 TO 11+00

7 MISCELLANEOUS DETAILS

8 CROSS SECTIONS

9 CROSS SECTIONS

1	UTILITY OWNER	CONTACT	PHONE NO.
ı			
ı	AT&T (PACIFIC BELL)	CRAIG AKIN	714-666-5698
ı	CITY OF TUSTIN (WATER SERVICES DIVISION)	JOSE DIAZ	714–573–3375
	LEVEL (3) COMMUNICATIONS	MATT WILLIAMS	720–888–3813
l	MCI NETWORKS SERVICES, INC.	CHUCK TRIMBLE	909-421-3339
l	ORANGE COUNTY SANITATION DISTRICT	LYNN ELLIOTT	714–960–2411
ı	SOUTHERN CALIFORNIA EDISON	KIM GURULE	714–796–9932
	SOUTHERN CALIFORNIA GAS COMPANY	DAVE BALDWIN	714–634–3267
	TIME WARNER CABLE	CHRIS DONNELLY	714–412–8541
	UNDERGROUND SERVICE ALERT	FRED ADJARIAN	800–422–4133

BENCH MARK:

O.C.S. BM. #IRV-B-BM1 ELEV. = 119.091' LEVELED 1991 O.C.S. BM. #3E-82-71 ELEV. = 116.067' LEVELED 1991


ELEV. = 116.067' LEVELED 1991 NGVD 1929 (1995 O.C.S. ADJUSTMENT)

THE BASIS OF BEARINGS HEREON IS THE GRID INVERSE BETWEEN OCS GPS STATIONS #6539 AND #6540, BEING N 40^36'56" E.

COORDINATES SHOWN HEREON ARE


BASIS OF BEARINGS:


COORDINATES SHOWN HEREON ARE BASED ON THE CALIFORNIA COORDINATE SYSTEM (CCS83), ZONE VI, 1983 NORTH AMERICAN DATUM (1991.35 EPOCH G.P.S. ADJUSTMENT).

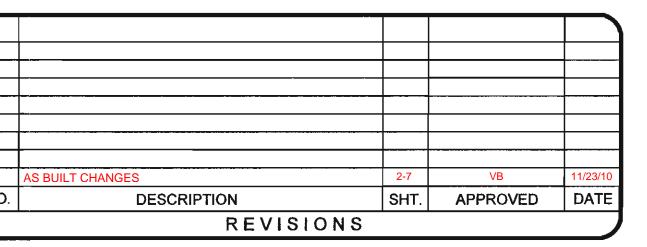

W. O. NO. <u>ER08960</u> DWG. NO. ____ SHEET 1 OF

OF 9

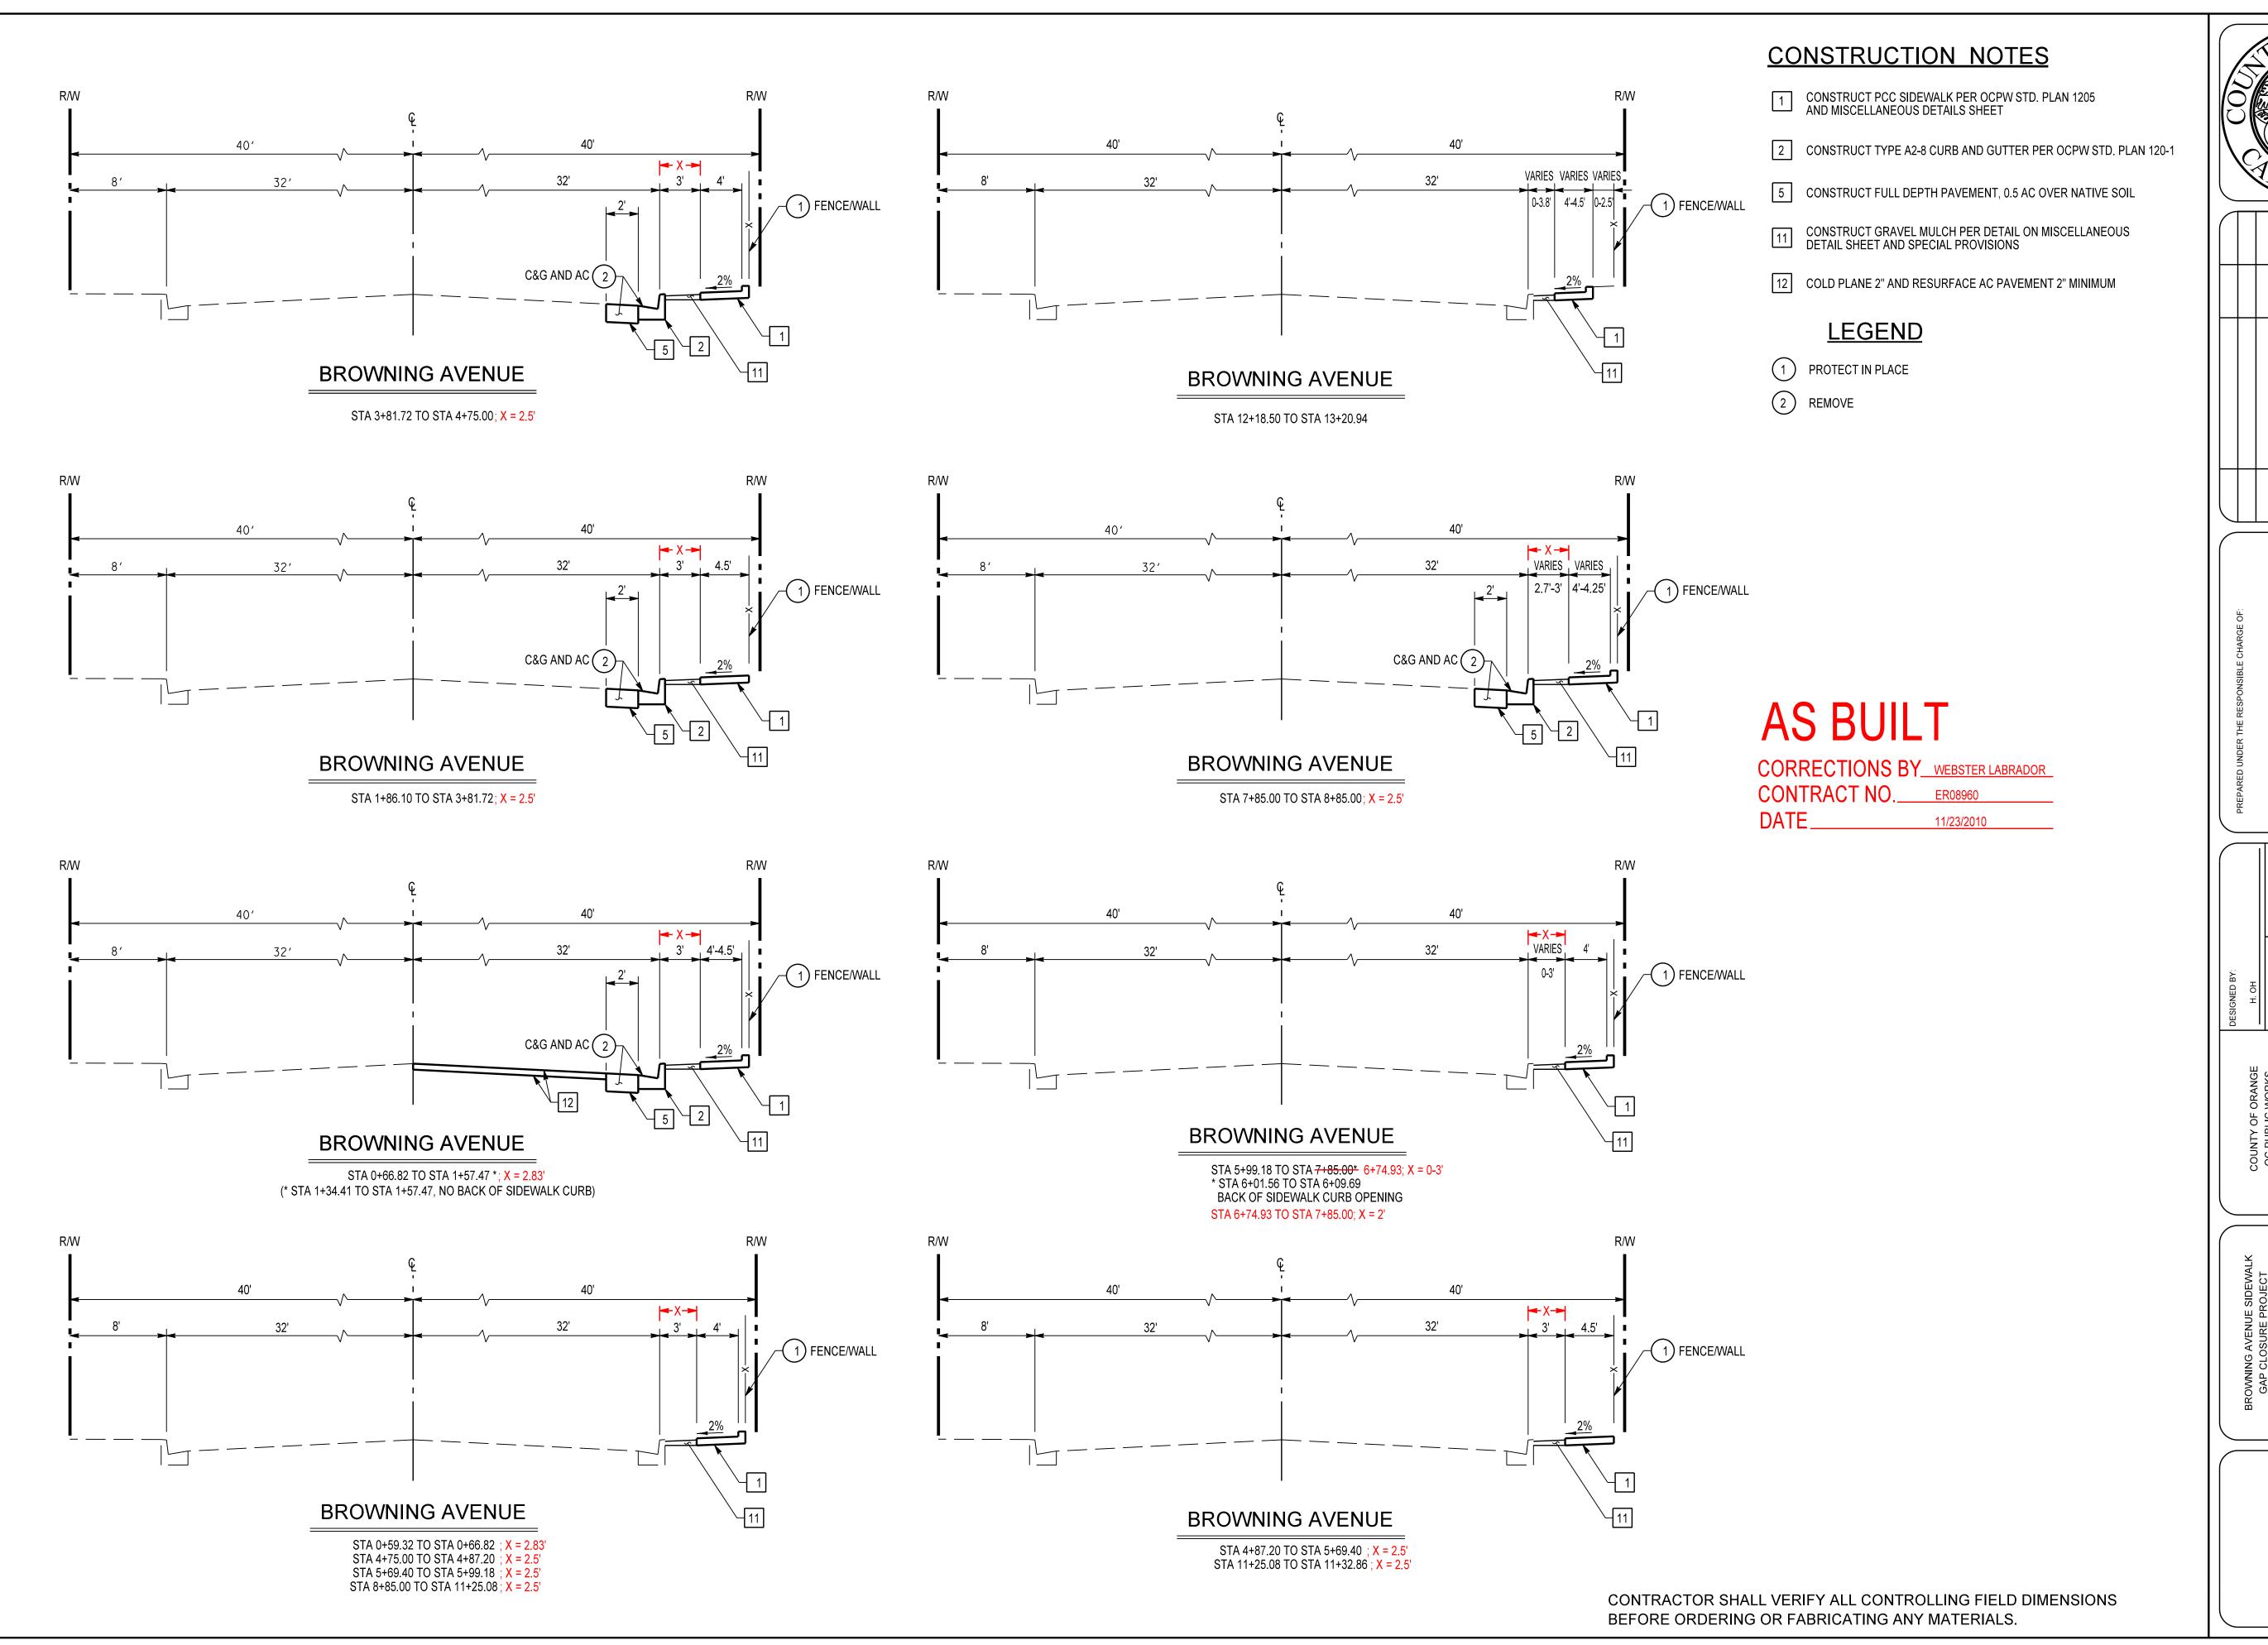

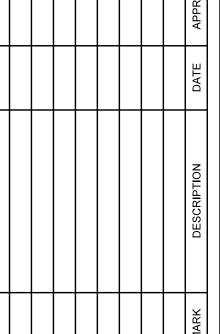

EPARED UNDER THE RESPONSIBLE CHARGE OF:


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COUNTY OF ORANGE	н. ОН	
OC PUBLIC WORKS	DRAWN BY:	CHECKED BY:
	Н. ОН	R. HOISIN
	DRAWING CODE:	
PREPARED BY: RIDGE DESIGN SECTION	FILE NAME:	
	PLOT DATE:	SCALE:


YPICAL CROSS
SECTIONS


Sheet Reference Number

Sheet 2 of 9



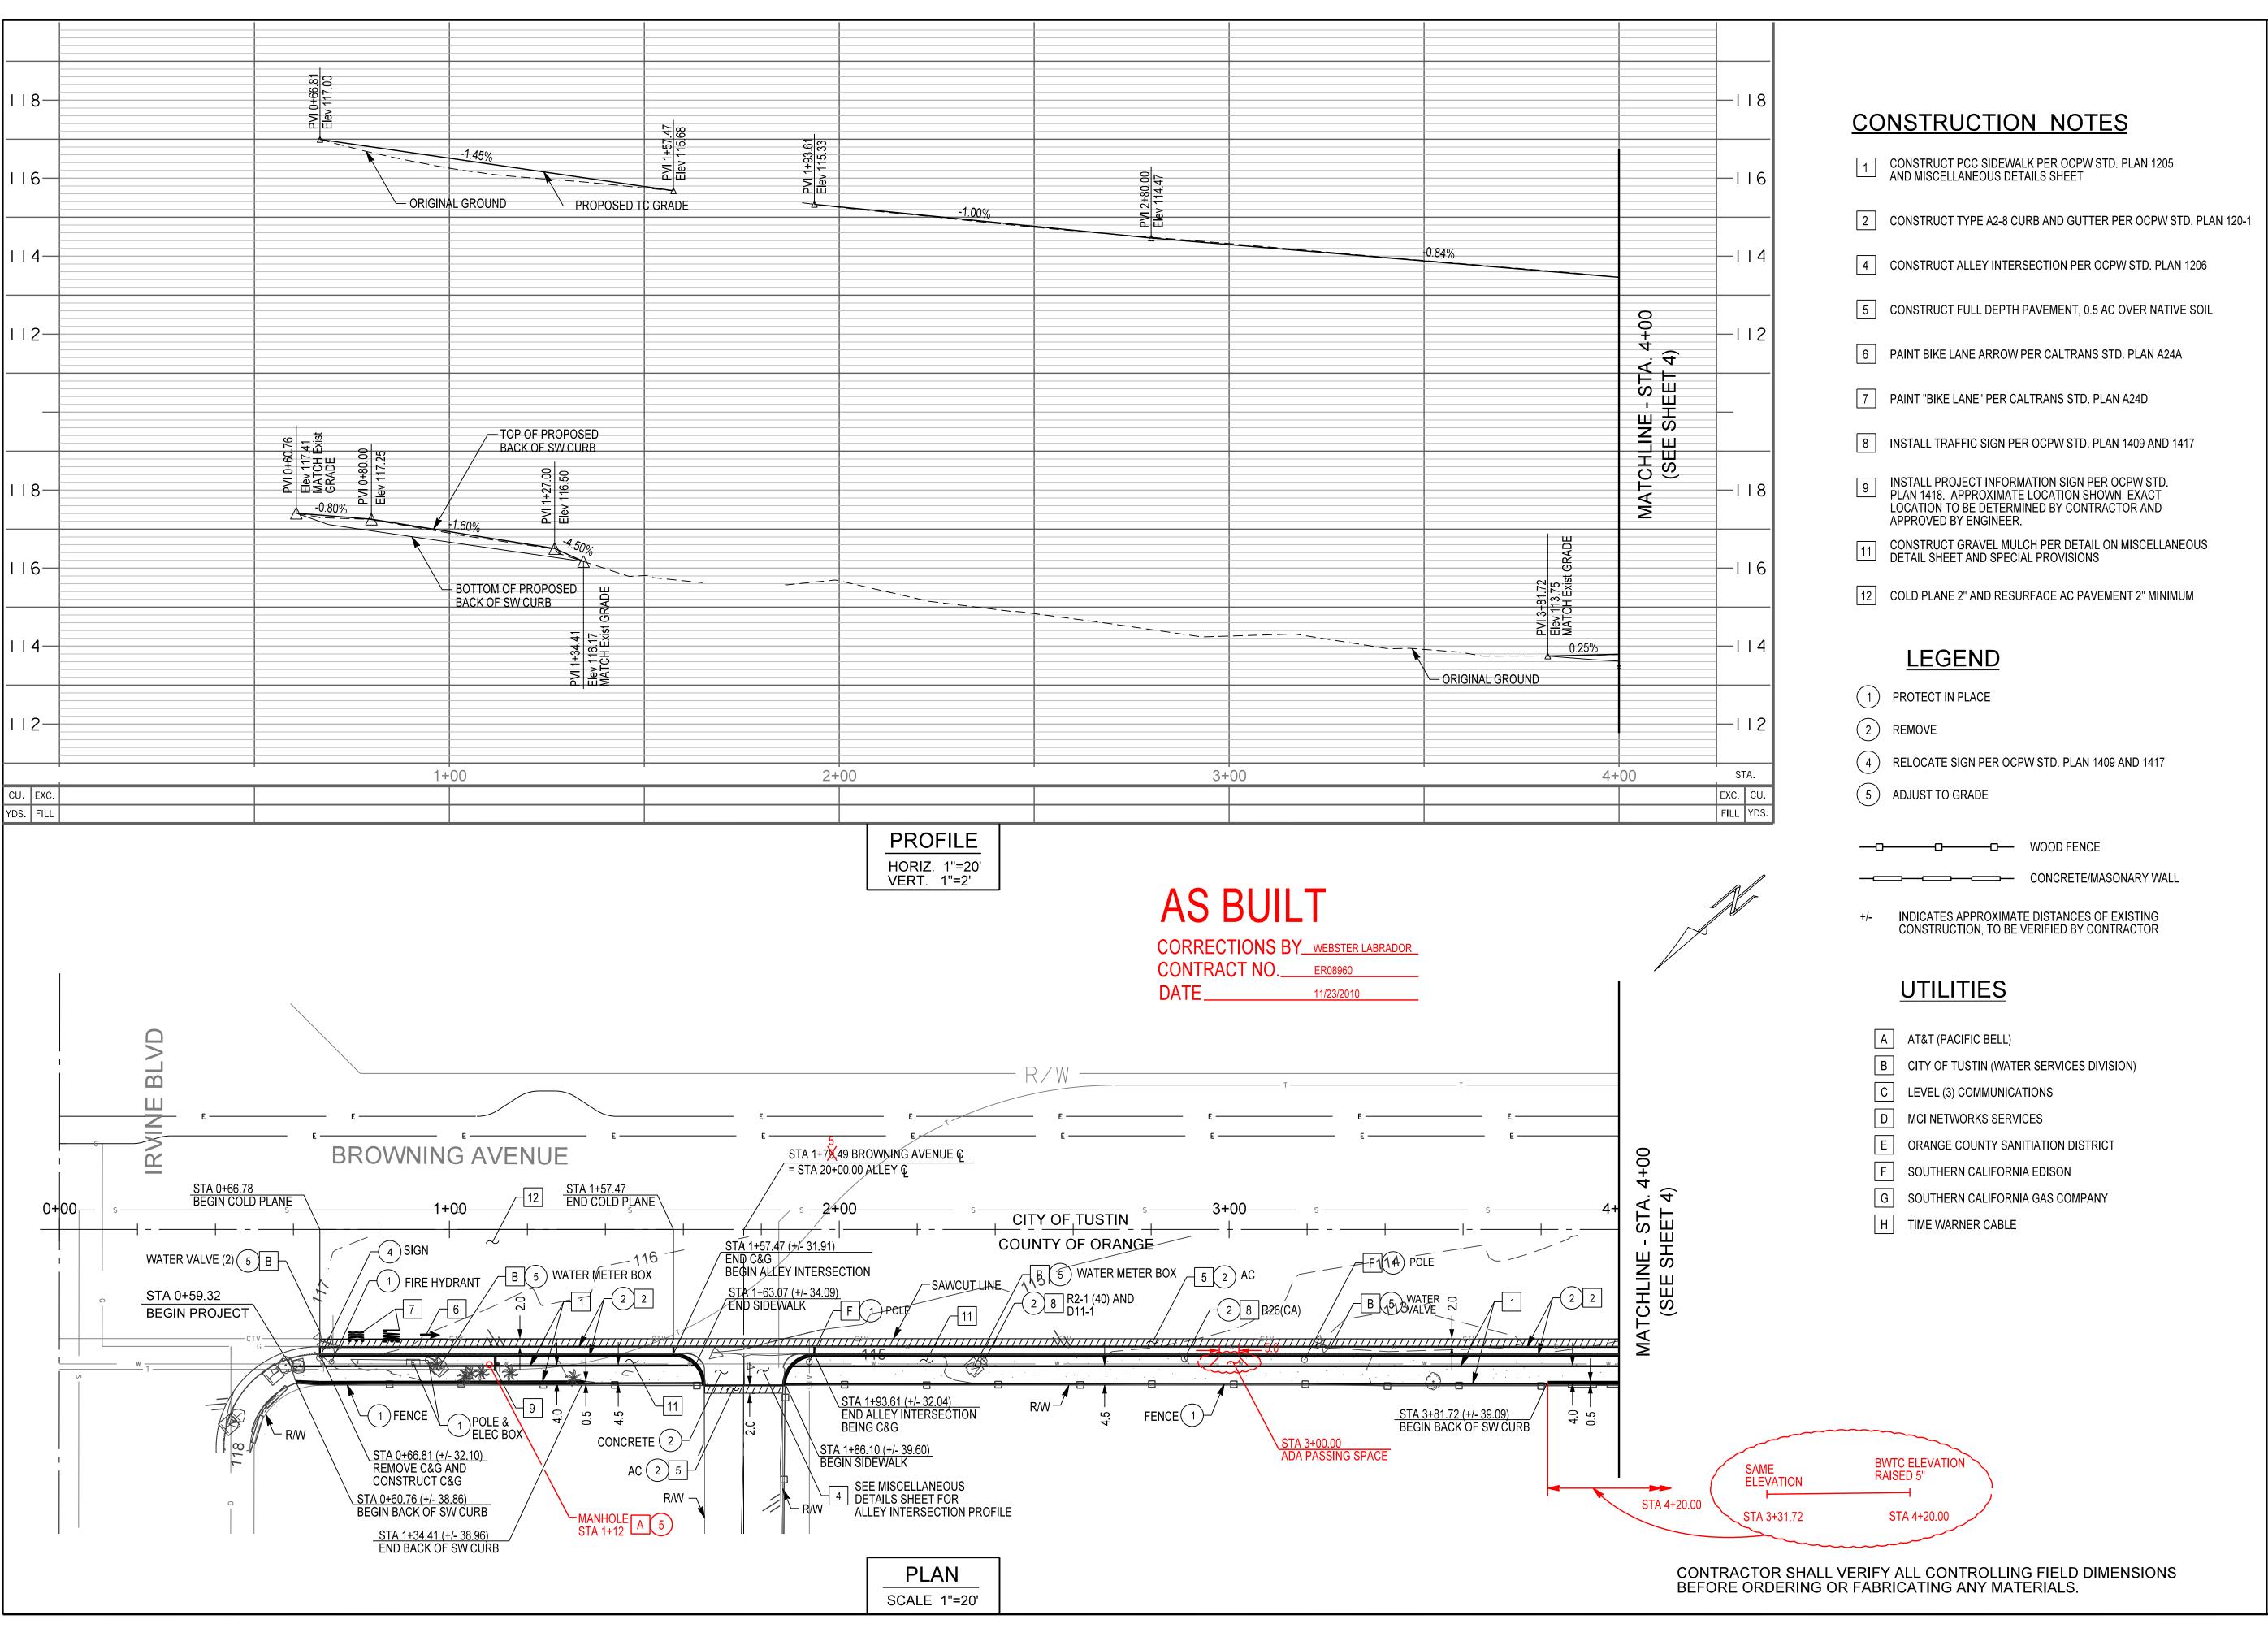

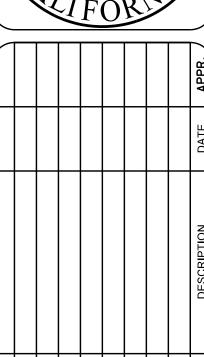

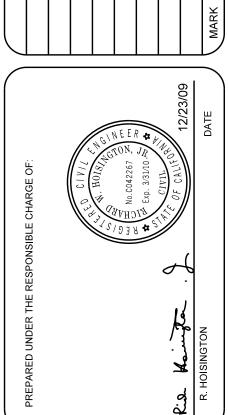


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COUNTY OF ORANGE	Н. ОН	
OC PUBLIC WORKS	DRAWN BY:	CHECKED BY:
	Н. ОН	R. HOISINGTON
	DRAWING CODE:	
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	PLOT DATE:	SCALE:


PLAN AND PROFILE


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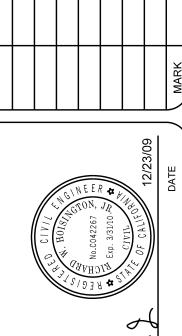
Sheet 3 of 9



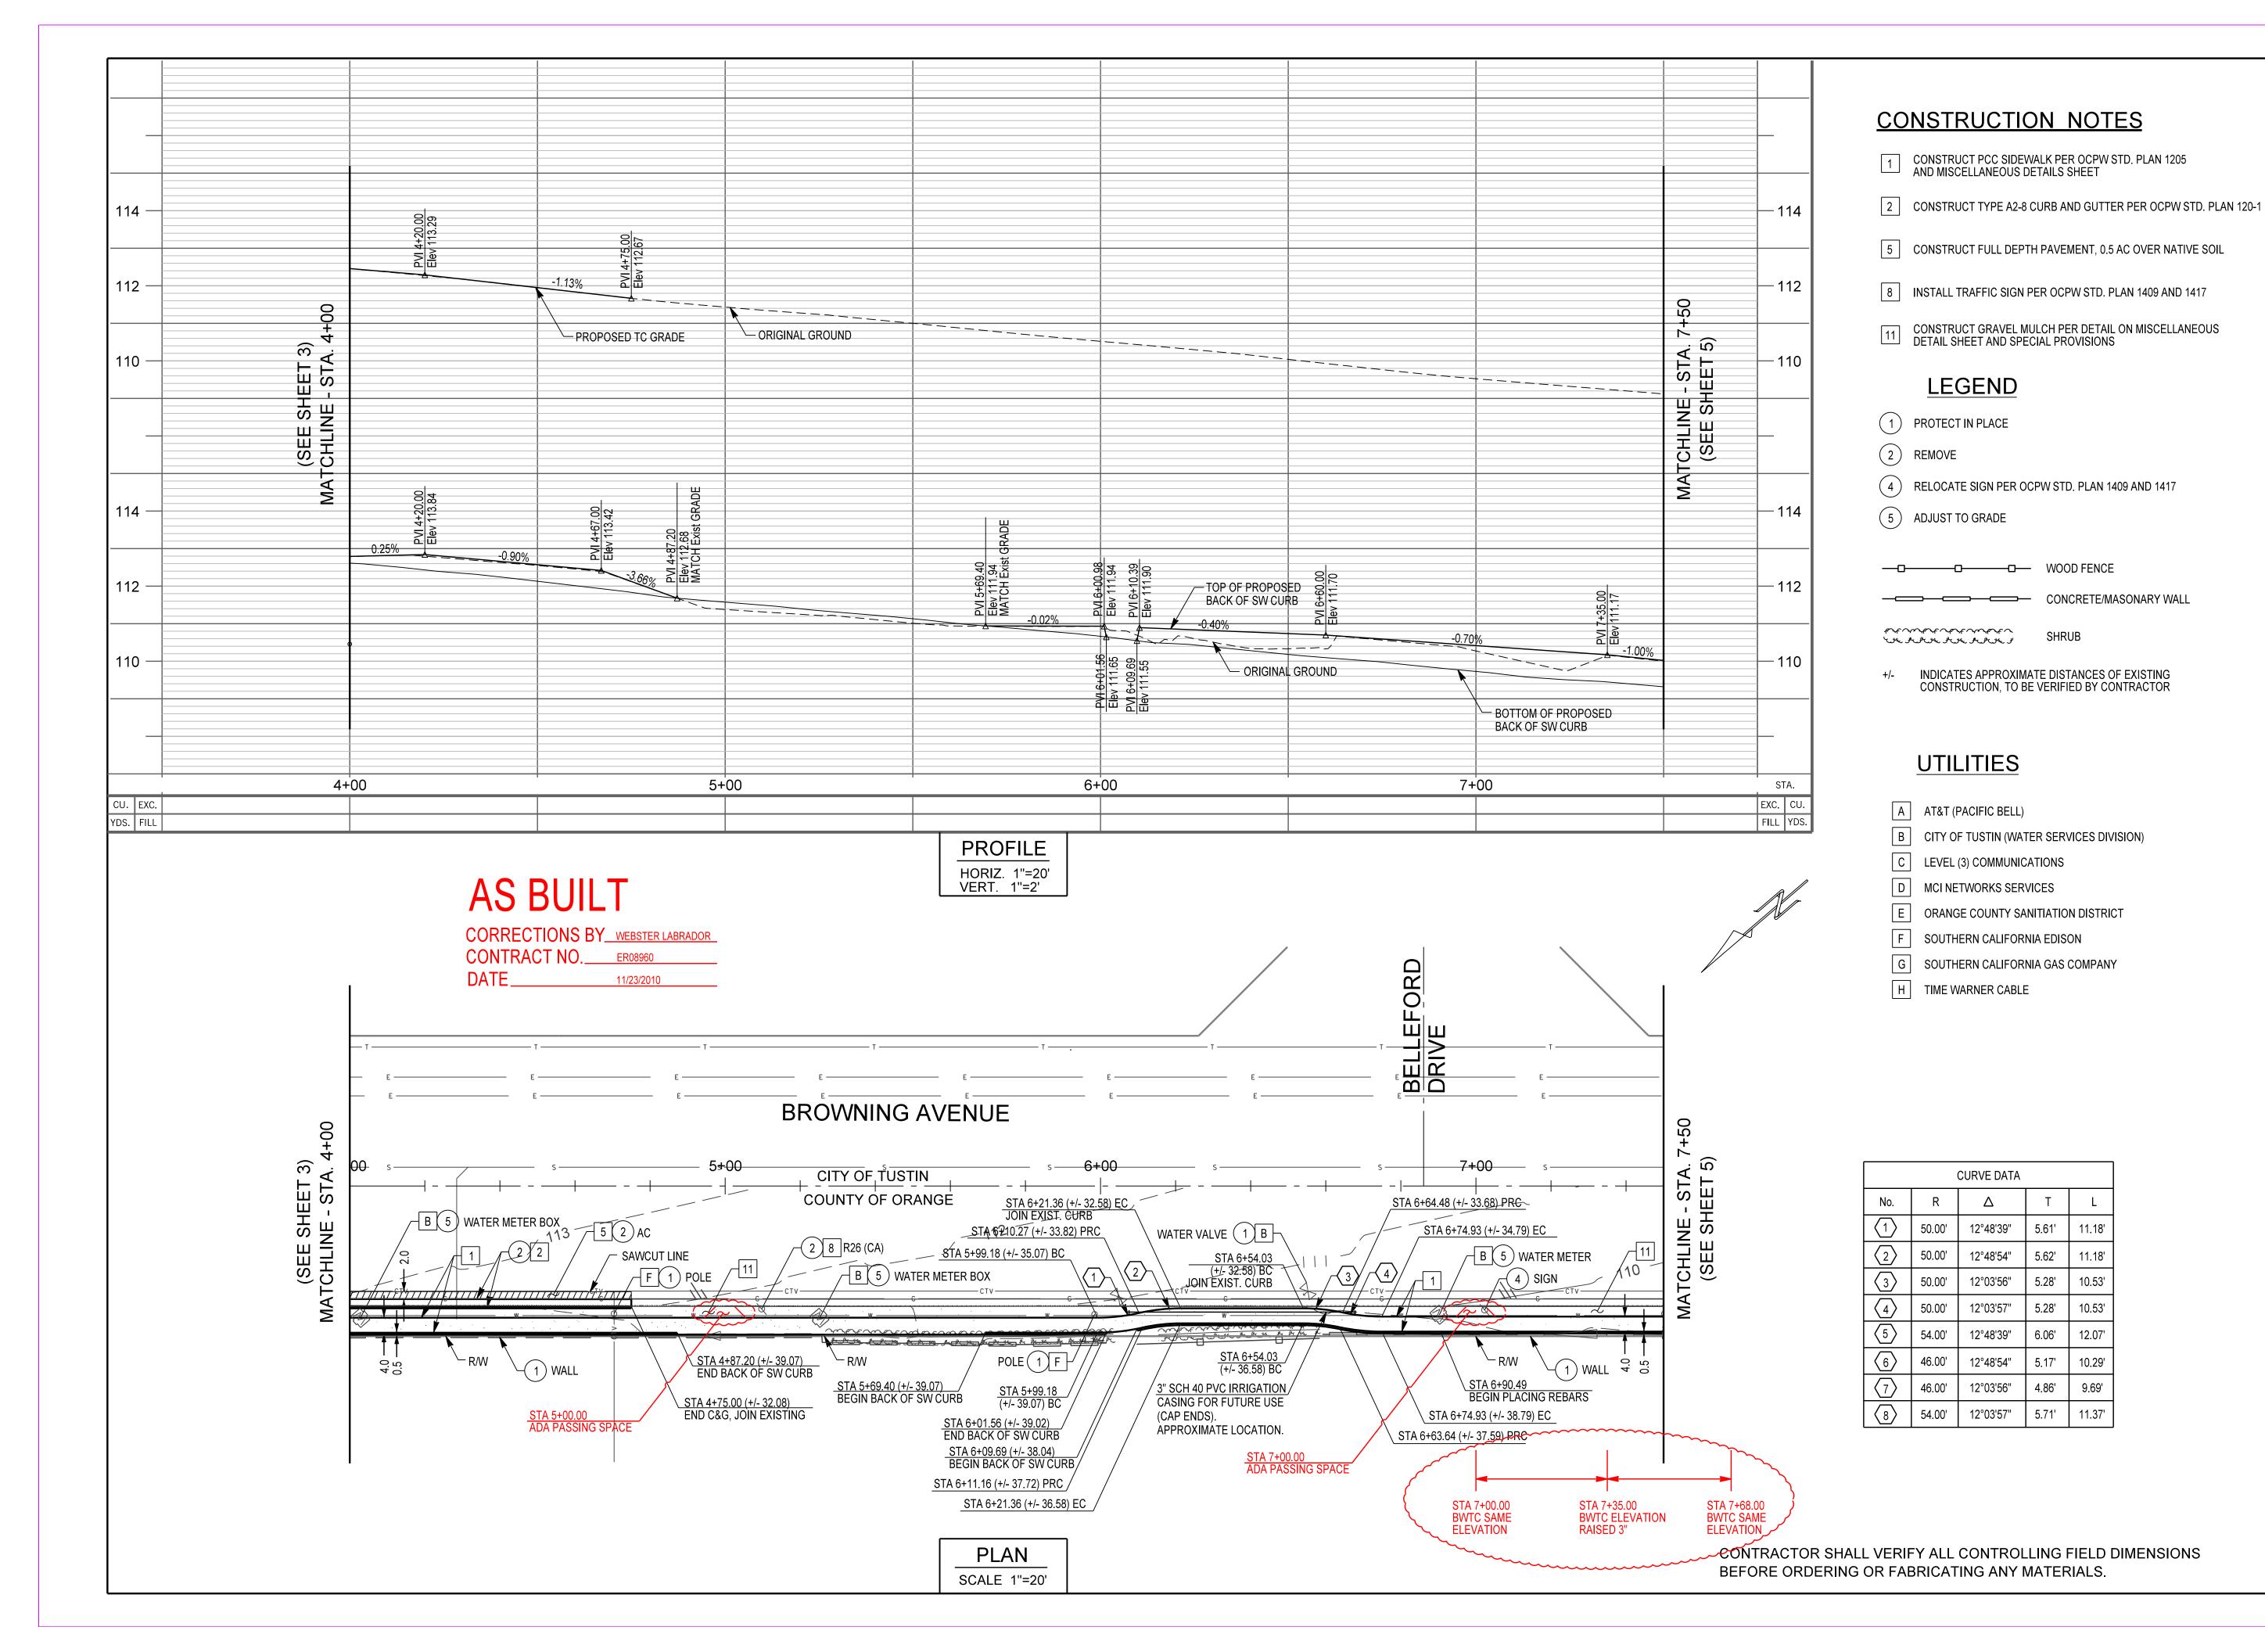



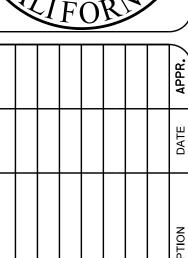

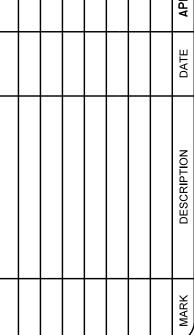


PREPARED UNDER THE RESPONSIBLE CHARGE OF:		Color M. HOUST CO.	# REG / W. CO42267 / W. V.	VINDO VIALO VIA	Ris Kennife . J. Chill 12/23/1	R. HOISINGTON
		NO NO				

	DESIGNED BY:	
COUNTY OF ORANGE	Н. ОН	
OC PUBLIC WORKS	DRAWN BY:	CHECKED BY:
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	DRAWING CODE:	
PREPARED BY:	FILE NAME:	
BRIDGE DESIGN SECTION		
	PI OT DATE:	SCALE


PLAN AND PROFILE

Sheet Reference

Sheet 4 of 9

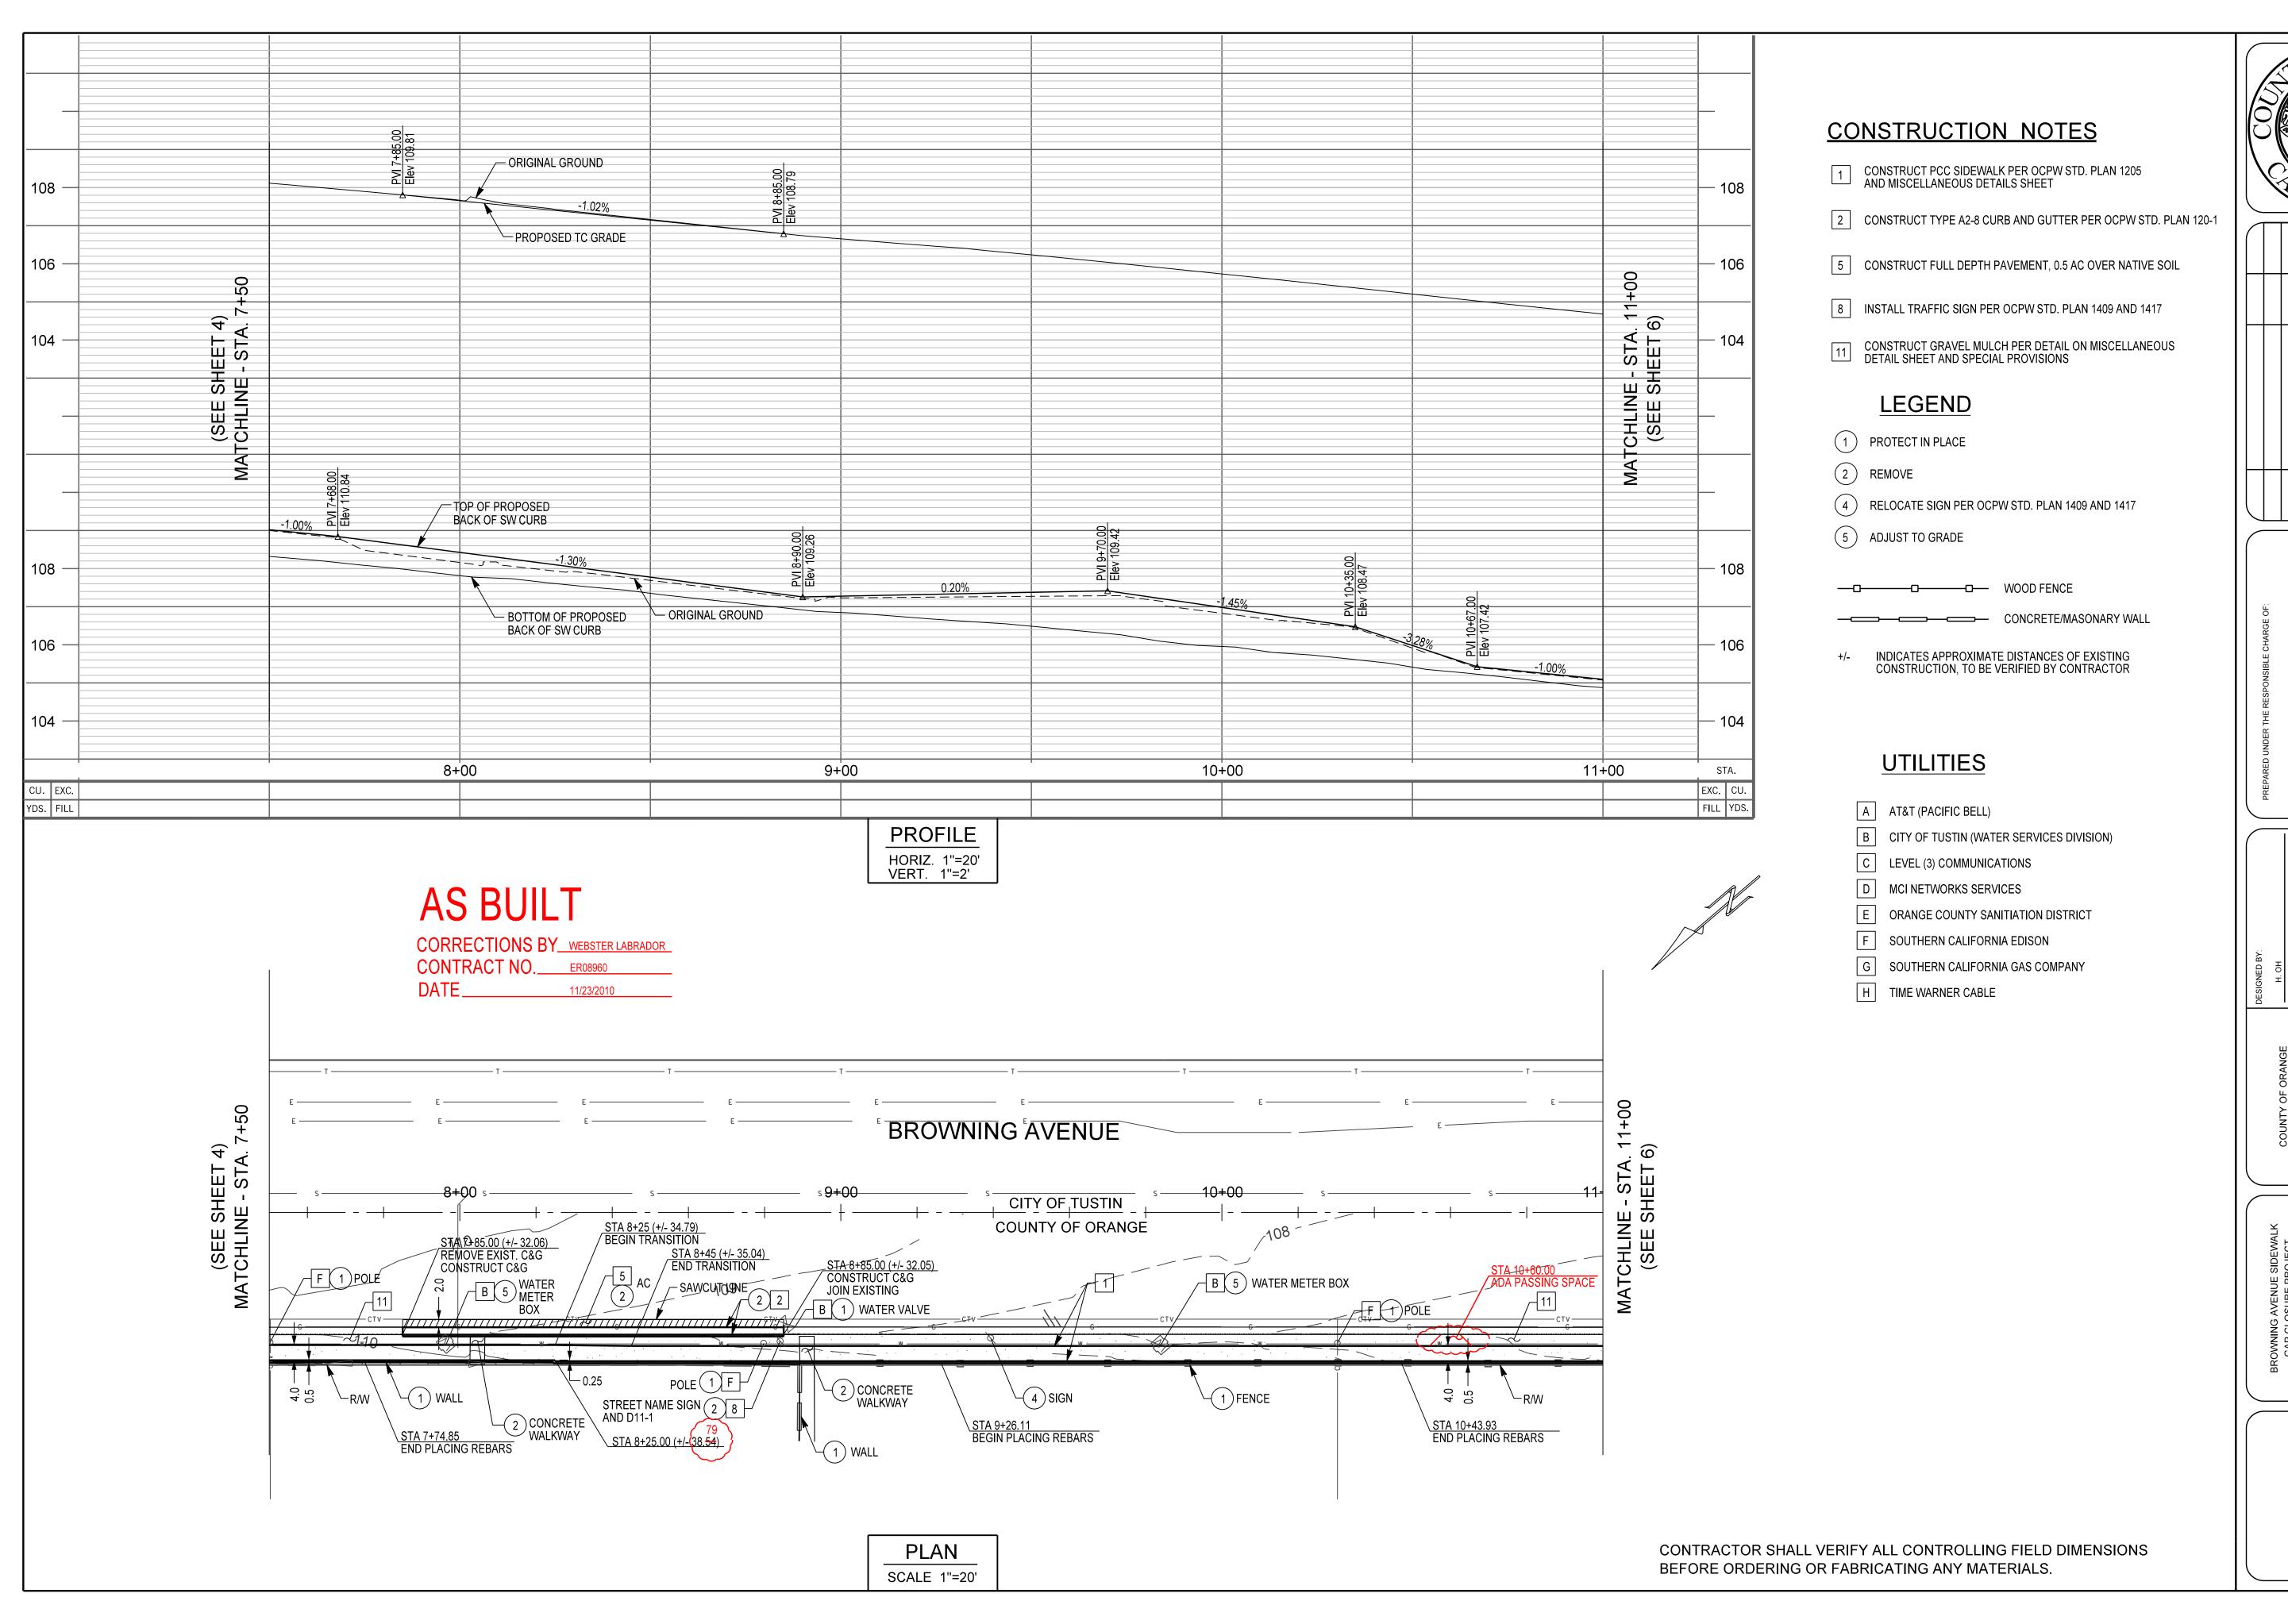




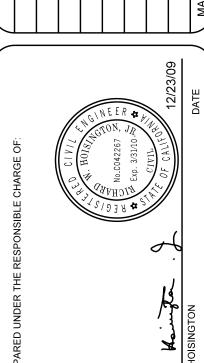


,		CHECKED BY:	R. HOISINGTON			L 1800
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	COUNTY OF ORANGE	OC PUBLIC WORKS			PREPARED BY: BRIDGE DESIGN SECTION	


Sheet Reference

Sheet 5 of 9

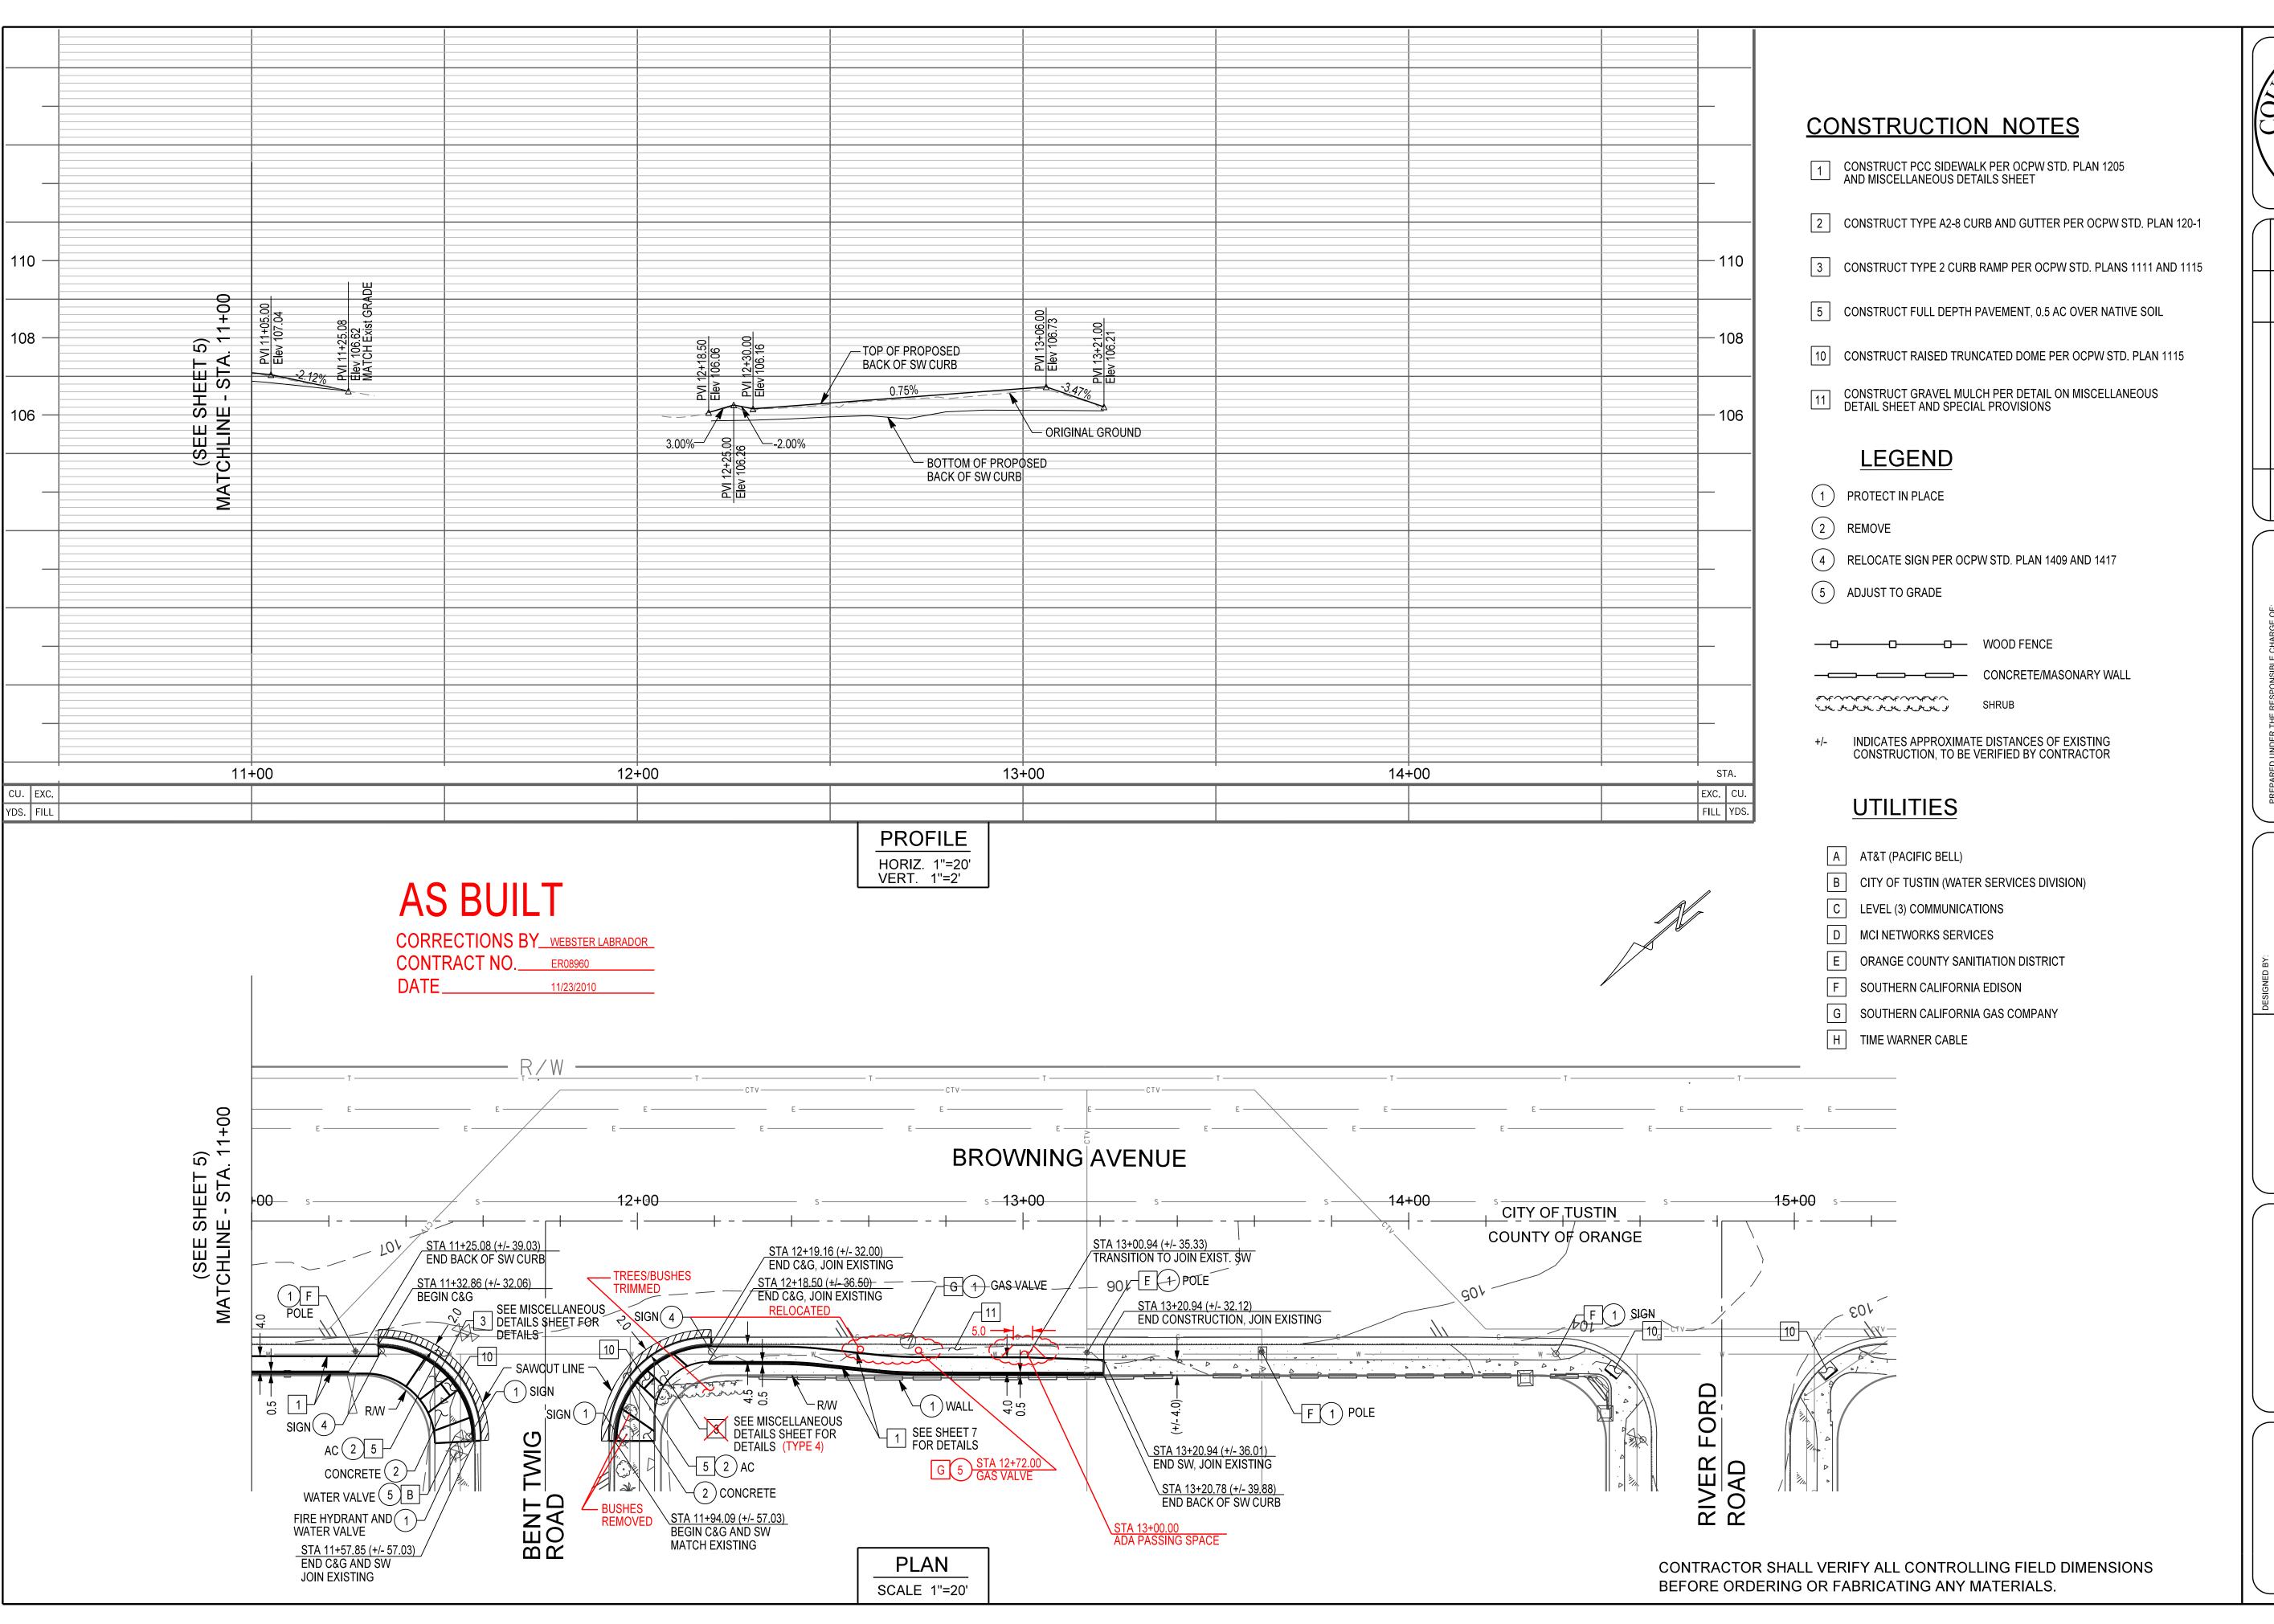



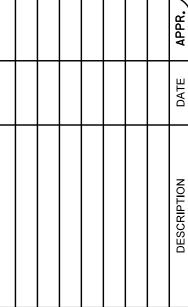

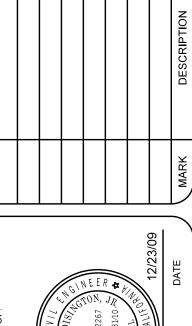



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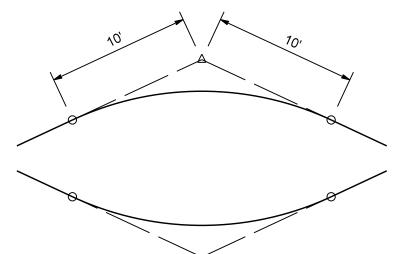
PLAN AND
PROFILE

Sheet Reference Number


Sheet 6 of 9

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E NAME: S:\Road Projects\Browning Ave\Design\CAD\She




20' VERTICAL CURVE AT TOP OF SW CURB SLOPE CHANGE (TYP.)

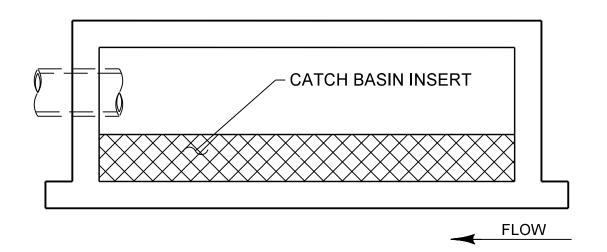


CATCH BASIN (PLAN VIEW)

NOTE: CATCH BASIN-INLET TYPE OL, LOCATED ON BROWNING AVENUE, 35' NORTH OF NORTH WEST CORNER OF BROWNING AVENUE AND BRYAN AVENUE INTERSECTION (SEE LOCATION MAP ON SHT 1). INSTALL CATCH BASIN INLET INSERT AND AUTOMATIC RETRACTABLE INLET SCREEN COVER PER SPECIAL PROVISIONS AND MANUFACTURER'S STANDARDS.

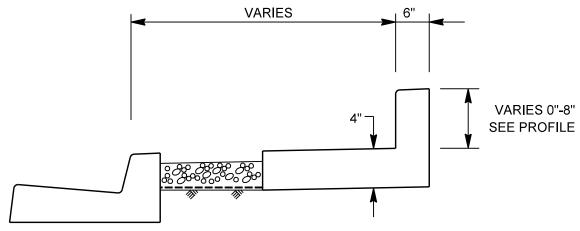

NOTE: SIDEWALK AND SW CURB SHALL BE A SINGLE POUR (NO JOINTS)

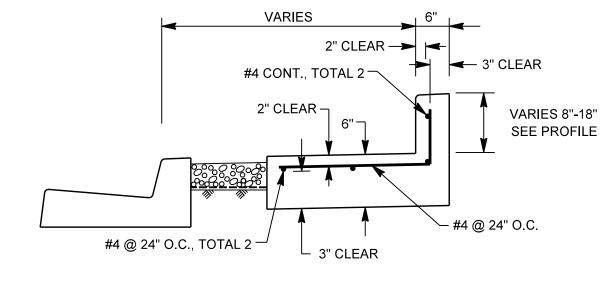

BACK OF SW CURB DETAIL FOR CURB HEIGHT > 8"

STA 12+37.35

(+/- 32.56) BC

- CURB RAMP TYPE 4

STA 12+04.46 (+/- 51.01)

STA 12+04.46 (+/- 57.01)
BEGIN CURB RAMP AND

MATCH Exist

NTS

MATCH Exist FL (105.18 FL)

NOTE: SIDEWALK AND SW CURB SHALL BE A SINGLE POUR (NO JOINTS)

AS BUILT

STA 12+47.74 (+/- 33.13) EC

STA 12+37.34 (+/- 36.56) BC

STA 12+47.31 (+/- 37.11) EC

CORRECTIONS BY WEBSTER LABRADOR CONTRACT NO. ER08960


STA 12+62 32 (+/- 34,69) BC

STA 12+72,34.55

(+/- 39.27) EC


<u>STA 12+62<mark>X</mark>1 (+/- 38,7X)</u> BC


DATE_

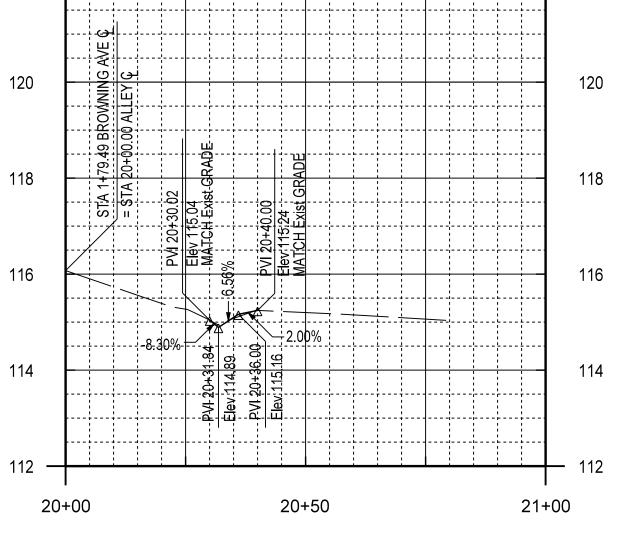

ALLEY INTERSECTION PROFILE

SCALE: HORIZ 1" = 20' VERT 1" = 2'

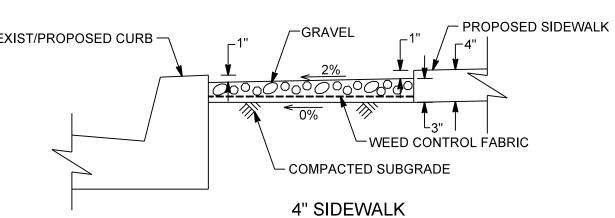

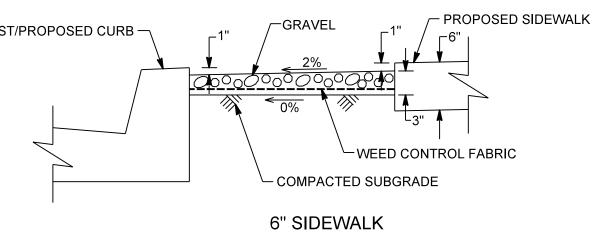


GRAVEL MULCH NTS

			CUF	RVE DATA	١				
No.	R	Δ	Т	L	No.	R	Δ	Т	L
9	25.00'	89°53'57"	24.96'	39.23'	(13)	100.00'	5°57'55"	5.21'	10.41'
(10)	18.00'	90°13'13"	18.07'	28.34'	(14)	96.00'	5°57'55"	5.00'	9.99'
11	25.00'	90°11'57"	25.09'	39.36'	(15)	100.00'	5°59'58"	5.24'	10.47'
(12)	14.00'	90°11'38"	14.05'	22.04'	(16)	96.00'	5°59'58"	5.03'	10.05'

CONTRACTOR SHALL VERIFY ALL CONTROLLING FIELD DIMENSIONS BEFORE ORDERING OR FABRICATING ANY MATERIALS.

EXIST/PROPOSED CURB	GRAVEL OCOCOCOCOCOCOCOCOCOCOCOCOCOCOCOCOCOCO
I	4" SIDEWALK_
EXIST/PROPOSED CURB	GRAVEL PROPOSED SIDEWALK 2% 000000000000000000000000000000000

			CUF	RVE DATA	١				
No.	R	Δ	Т	L	No.	R	Δ	Т	L
9	25.00'	89°53'57"	24.96'	39.23'	(13)	100.00'	5°57'55"	5.21'	10.41'
10	18.00'	90°13'13"	18.07'	28.34'	(14)	96.00'	5°57'55"	5.00'	9.99'
11	25.00'	90°11'57"	25.09'	39.36'	(15)	100.00'	5°59'58"	5.24'	10.47'
12	14.00'	90°11'38"	14.05'	22.04'	(16)	96.00'	5°59'58"	5.03'	10.05'

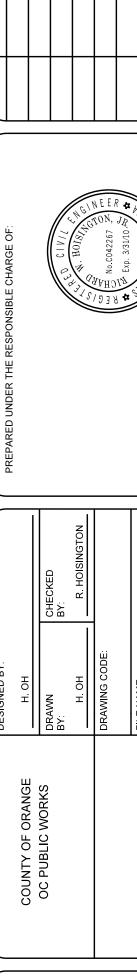


MISCELLANEOUS DETAILS


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Reference

NTS

BACK OF SW CURB DETAIL FOR CURB HEIGHT ≤ 8" NTS



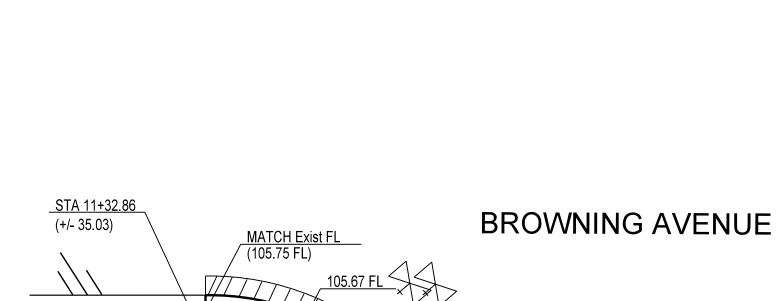

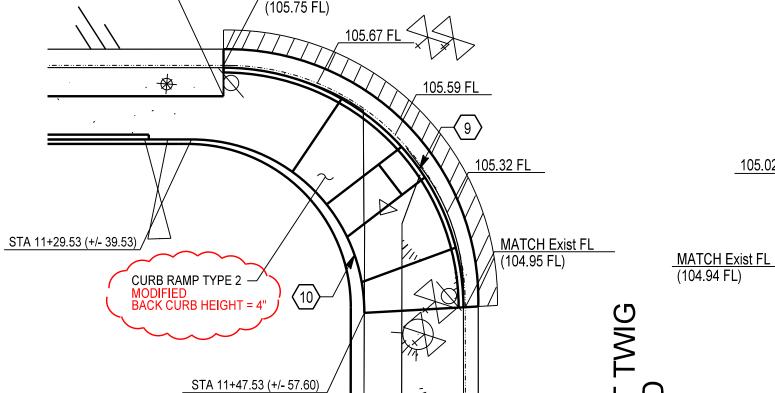BENT END CURB RAMP AND MATCH Exist

CURB RAMP AND SIDEWALK DETAILS


SCALE 1"=10'


25 2+20 25 7+20 25 3+20 25 2+00 R/W R/W 25 3+80 5+20 25 6+60 25 1+20 25 2+60 R/W 25 I+00 25 3+60 5+00 25 6+40 25 0+80 25 6+20 25 25 25 2+40 3+40 4+80









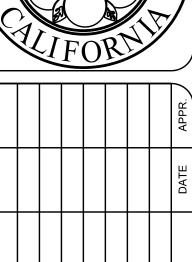

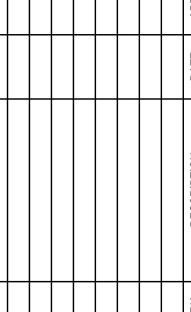

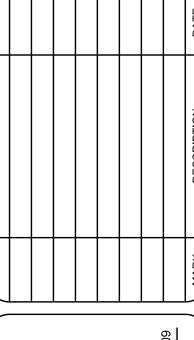

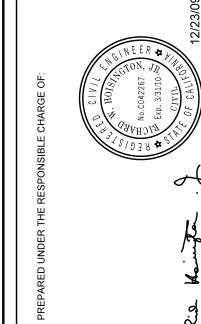

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COUNTY OF ORANGE	н. он	
OC PUBLIC WORKS	DRAWN BY:	CHECKED BY:
	H. OH	R. HOISIN
	DRAWING CODE:	
PREPARED BY: BRIDGE DESIGN SECTION	FILE NAME:	
	PLOT DATE:	SCALE:

CROSS SECTIONS STA 0+80 TO STA 7+20

Sheet Reference Number

Sheet 8 of 9


SCALE: HORIZ 1"=20'


VERT 1"=5'

8+60 9+80 11+20 7+60 8+40 9+60 11+00 13+20 7+40 8+20 9+40 10+80 13+00

NO AS BUILT CHANGES



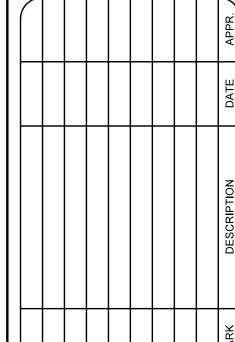

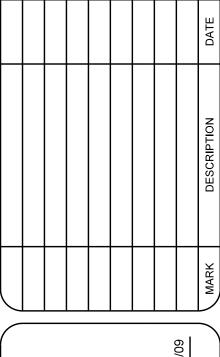



	DESIGNED BY:	
COUNTY OF ORANGE	Н. ОН	
OC PUBLIC WORKS	DRAWN BY:	CHECKED BY:
	н. он	R. HOISINGTON
	DRAWING CODE:	
PREPARED BY: BRIDGE DESIGN SECTION	FILE NAME:	
	PLOT DATE:	SCALE:

CROSS SECTIONS STA 7+40 TO STA 13+20

Sheet Reference Number

Sheet 9 of 9

SCALE: HORIZ 1"=20' VERT 1"=5'