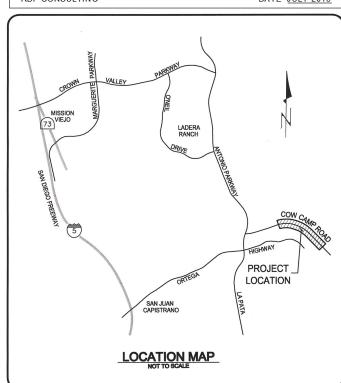


RECORD DRAWING

THIS RECORD DRAWING HAS BEEN PREPARED, IN PART, BASED UPON INFORMATION FURNISHED BY OTHERS. WHILE THIS INFORMATION IS BELIEVED TO BE RELIABLE, THE ENGINEER CANNOT ASSURE ITS ACCURACY, AND THUS IS NOT RESPONSIBLE FOR THE ACCURACY OF THIS RECORD DRAWING OR FOR ANY ERRORS OR OMISSIONS WHICH MAY HAVE BEEN INCORPORATED INTO IT AS A RESULT. THOSE RELYING ON THIS RECORD DRAWING ARE ADVISED TO OBTAIN INDEPENDENT VERIFICATION OF ITS ACCURACY BEFORE APPLYING IT FOR ANY PURPOSE

RBF CONSULTING

DATE JULY 2015



COUNTY OF ORANGE OC PUBLIC WORKS

SANTA ANA, CALIFORNIA IGNACIO G. OCHOA, INTERIM DIRECTOR

PLANS FOR CONSTRUCTION OF

COW CAMP ROAD PHASE 1B

N'LY CHIQUITA CANYON BRIDGE TO 6,950' EAST OF ANTONIO PARKWAY STA. 29+00.00 TO STA. 79+50.00

MAY 2013

MAINTAINED BY:

COUNTY OF ORANGE: COW CAMP ROAD **HOA: WATER QUALITY BASINS** AGREEMENT # D13-018

WDID # 9 37C366333

RANCHO MISSION VIEJO

RANCHO MISSION VIEJO COMMUNITY DEVELOPMENT HEREBY CONCURS WITH THE ATTACHED PLANS, HOWEVER, RMY MAKES NO REPRESENTATION, WARRANTY OR GUARAMY AS TO THE CONTENT OR ACCURACY OF THE ATTACHED PLANS AND THE INFORMATION



PROJECT FUNDING SOURCE

Know what's below.

Call before you dig.

AS BUILT

CONTRACT No.

DATE ACCEPTED

County Inspection

Underground Service Ale

Call:811

PROJECT FUNDING WILL BE PROVIDED BY THE COUNTY OF ORANGI AND RANCHO MISSION VIEJO (RMV)

STANDARD PLAN NOTE


REFERENCES HEREIN TO "OCPW STANDARD PLANS" SHALL BE UNDERSTOOD TO REFER TO ORANGE COUNTY PUBLIC WORKS (OCPW) STANDARD PLANS 2006 EDITION

UTILITY OWNER	CONTACT	PHONE NO.
AT&T	VICTOR PEREZ	(714)666-5696
COX COMMUNICATIONS	MARTY ZUPANCIC	(949)546-2802
MWD	SUSAN WALTERS	(213)217-6679
RMV CONSTRUCTION	JACK MORALES	(949)240-3363
RMV OPERATIONS	DEREK KNOBEL	(949)422-7017
RMV PROJECT MGMT	JIM YATES	(949)240-3363
SDG&E	JAMES HINTON	(949)361-8004
SMWD	JAMIE AGUILAR	(949)459-6582
THE GAS COMPANY	MYRON DIEKMANN	(949)448-8514

GEOTECHNICAL CONSULTANT



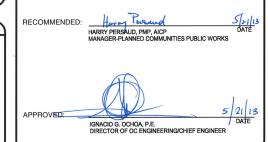ORANGE COUNTY PUBLIC WORKS



ORANGE COUNTY PUBLIC WORKS APPROVED DEVIATIONS FROM STANDARDS OF DESIGN

STREET AND DRAINAGE IMPROVEMENTS PER COUNTY STANDARDS EXCEPT FOR DEVIATIONS FROM STANDARDS OF DESIGN PER COPW STANDARD PLANS.

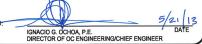
1. OCPW STANDARD PLANS: DEVIATION FROM THE CURRENT APRIL 2013 OCPW STANDARD PLANS. THE PROPOSED PLANS WERE INITIATED AND DEVELOPED

GRANDARD PLAN 120-2-00 FOR STANDARD CORD REIGHT FOR 45 MFT OR GREATER SPEED. THE PROPOSED PLANS WERE INITIATED AND DEVELOPED UNDER THE 2006 OCPW STANDARD PLANS IN 2011. FOLLOWING DESIGN DEVIATIONS ARE DOCUMENTED IN ATTACHMENT 18 OF APPROVED "PROJECT REPORT FOR COW CAMP ROAD IMPROVEMENTS: FROM ONIO PARKWAY TO "I" STREET", DATED 11-04-08 BY HUITT-ZOLLARS, INC.

SIDEWALK WIDTH REDUCTION FROM 9' STANDARD: DEVIATION FROM STANDARD PLAN 1101 FOR SIDEWALK WIDTH STANDARDS FOR MAJOR HIGHWAY FROM 9' TO A 6' CURB ADJACENT SIDEWALK. WIDTHS WERE REDUCED TO FACILITATE ULTIMATE PEDESTRIAN CIRCULATION NEEDS BASED ON LAND USE PLANNING AND THE ADJACENT NEV/REGIONAL CLASS 1 BIKE AND


REPLACE FENCE ON BRIDGE BARRIER WITH WOOD RAILING PER SPECIFICATION: REPLACE THE STANDARD CHAIN LINK FENCE ON BOTH SIDES OF THE NORTHERLY CHIQUITY CANYON BRIDGE WITH WOOD RAILING. THIS DEVIATION COMPLIES WITH TRAFFIC AND PEDESTRIAN RAILING

ELIMINATE BRIDGE BARRIER BETWEEN SIDEWALK AND OUTSIDE SHOULDER ON BRIDGE: ELIMINATED BRIDGE BARRIER BETWEEN SIDEWALK AND OUTSIDE SHOULDER ON BRIDGE DUE TO MINIMUM PEDESTRIAN TRAFFIC. ADDITIONALLY, IT WILL CREATE AN UNSAFE CONDITION BY RESTRICTING ACCESS TO THE SIDEWALK AND IN INCONSISTENT WITH PEDESTRIAN SAFETY REQUIREMENTS BEYOND THE LIMITS OF THE BRIDGE.



PREPARED BY



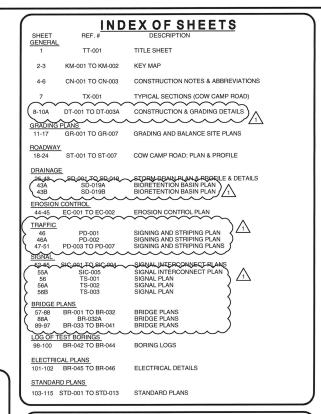

BASIS OF COORDINATES:

BEARINGS AND COORDINATES AS SHOWN HEREON ARE IN TERMS OF THE CALIFORNIA COORDINATE SYSTEM OF 1983 (CCS83, EPOCH 1991.35), ZONE 6, BASED LOCALLY UPON THE FOLLOWING CONTROL STATIONS AS PUBLISHED BY THE COUNTY OF ORANGE (OCS) AND

NAME	NORTHING (FT.) - GRID	EASTING (FT.) - GRID
OCS GPS 2592 (BM AP-02-99)	2,137,246.69	6,144,438.33
OCS GPS 2593 (BM AP-03-99)	2,139,863.76	6,143,906.08
TDARLICO	2 140 142 67	6 133 776 31

RMV CONTROL CONVERSION **GRID AND GROUND COORDINATES**

THIS CONVERSION IS BASED ON THE OLD CONTROL POINT "TRABUCO" AS OUR HOLD POINT OF

GRID COORDINATES ARE BASED ON ORANGE COUNTY SURVEYOR CONTROL NETWORK, CCS83. ZONE VI. 1991.35 EPOCH ADJUSTMENT. PROJECT C-FACTOR FOR RMV IS 0.99

(GROUND COORDINATE)

TO MOVE AN ITEM FROM GRID TO GROUND, MOVE FROM THE GRID COORDINATE TO THE GROUND COORDINATE AND SCALE THE POINTS FROM TRABUCO USING A FACTOR OF

TO MOVE AN ITEM FROM GROUND TO GRID. MOVE FROM THE GROUND COORDINATE TO THE GRID COORDINATE AND SCALE THE POINTS FROM TRABUCO USING A FACTOR OF 0.9999

COORDINATES AND HORIZONTAL DISTANCES SHOWN HEREON ARE IN TERMS THE RMV GROUND CONTRO

BENCH MARK (NAVD88):


OCS BM "AP-02-99" (NAVD88) ELEVATION: 238.11


FOUND 3-3/4" OCS ALUMINUM BENCHMARK DISK STAMPED "AP-02-99", SET IN THE NORTHEASTERLY CORNER OF A CONCRETE BRIDGE DECK. MONUMENT IS LOCATED IN THE NORTHEASTERLY CORNER OF ANTONIO PARKWAY AND ITS OVERCROSSING OF SAN JUAN CREEK.


3	RECORD DRAWING			7/31/15
2	Roadulay : Drainege revisions (Sheet 4-6, 8-11 11-17, 18-24, 25-45, 49-11, 12-55, 164 25	A)		
_	11-17, 18-24, 25-45, 49-11, 52-55, 56A & 5	(B)		
Λ	ROADWAY, GRADING, DRAINAGE, STRIPING,			
	SIGNAL, & BRIDGE REVISIONS			
NO.	DESCRIPTION	SHT.	APPROVED	DATE
	REVISIONS			

W. O. NO. ETD DWG. NO. ____TT-001

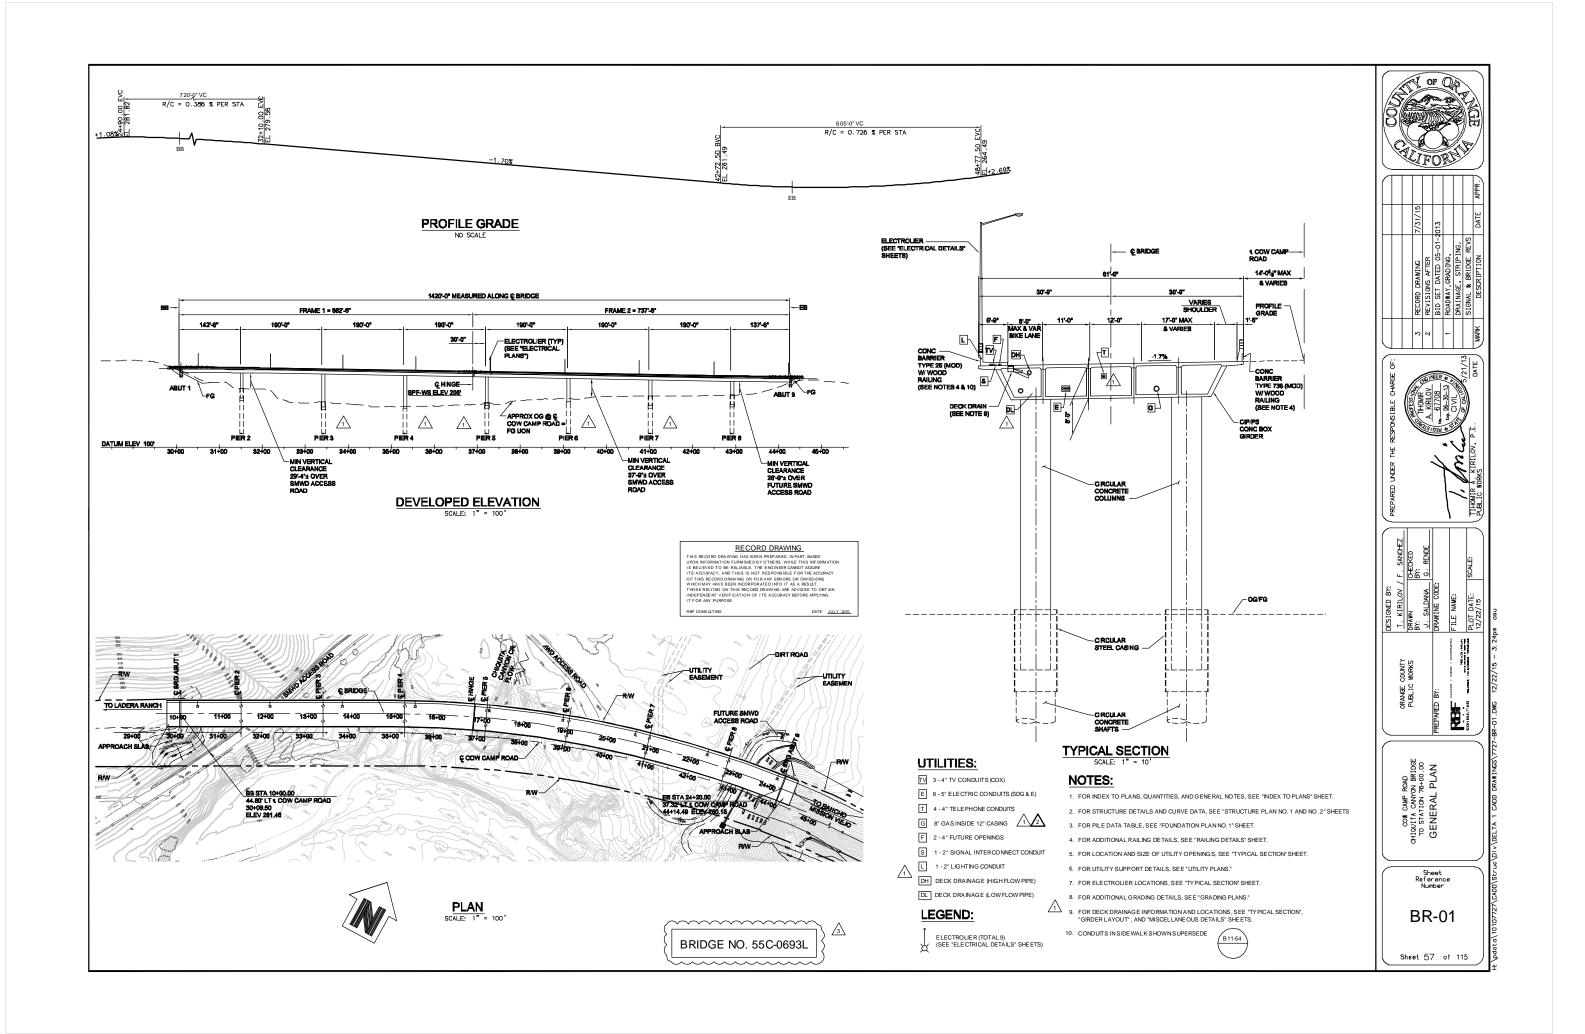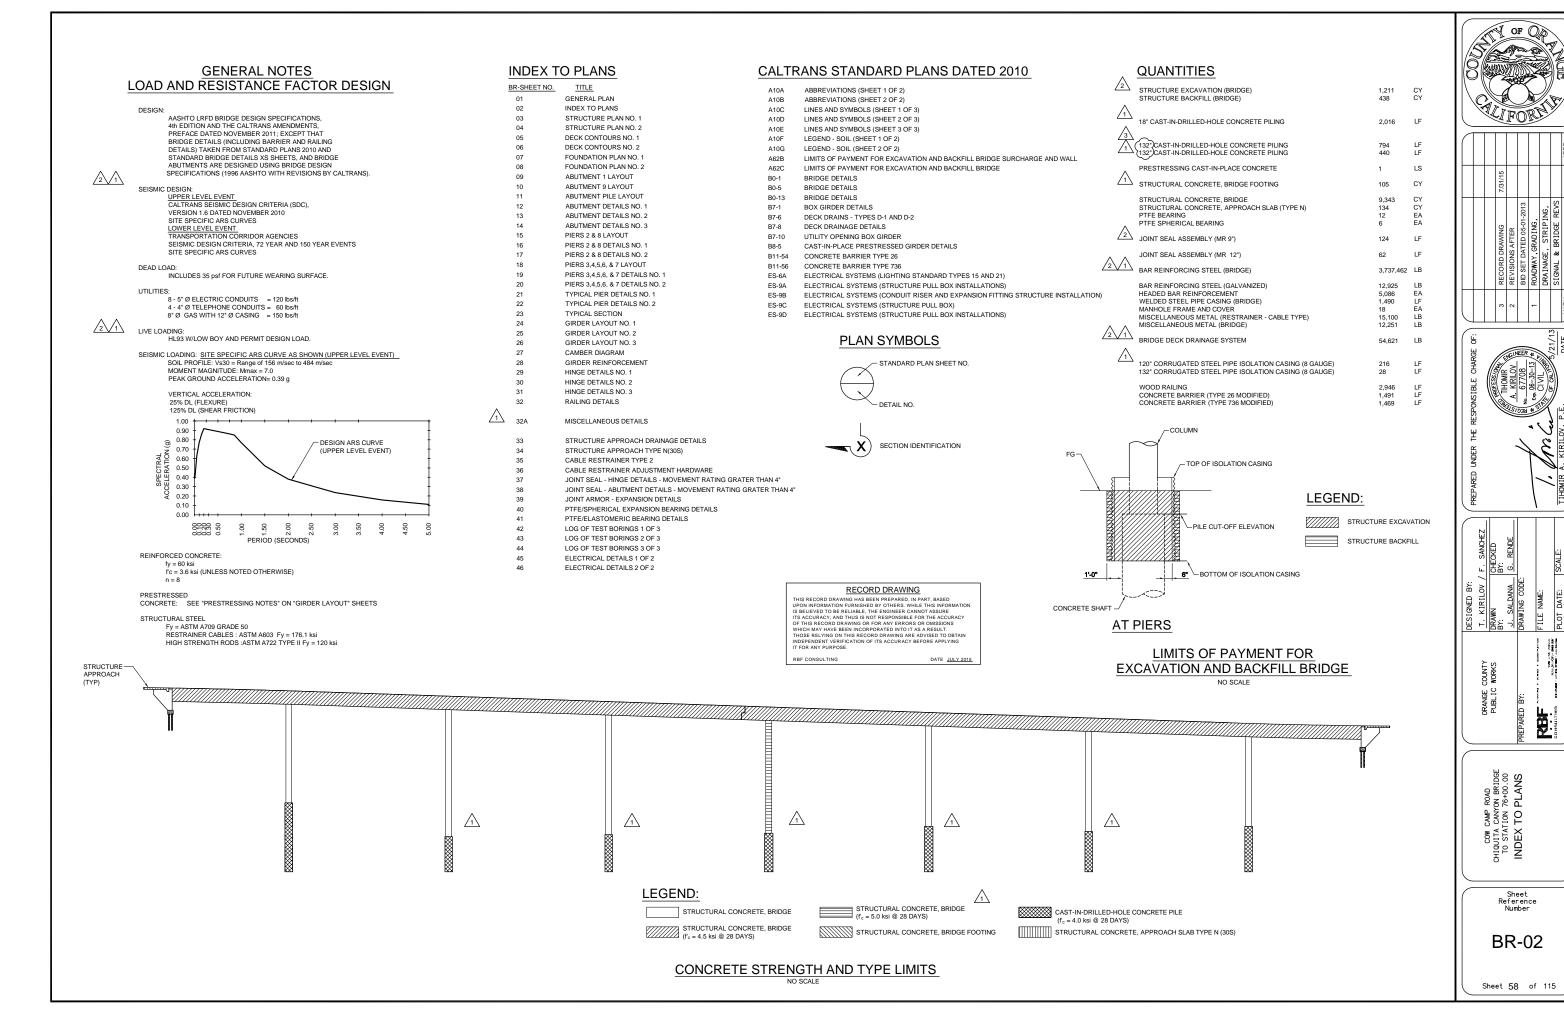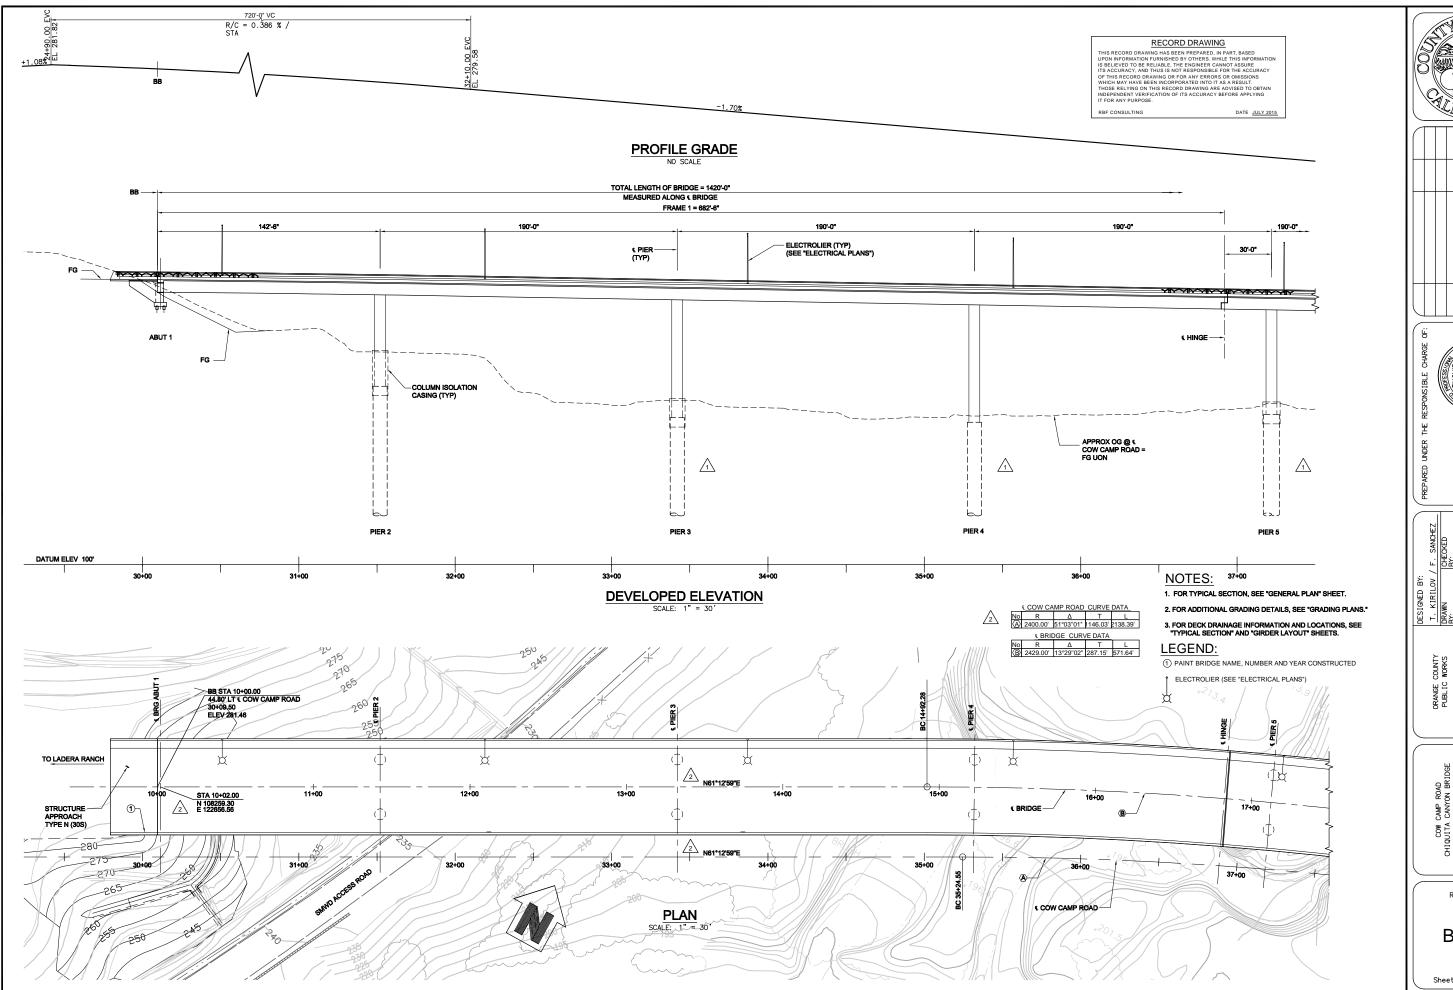SHEET 1 OF 115









							APPR
		7/31/15					DATE
		RECORD DRAWING	REVISE PER RFI #2	ROADWAY, GRADING,	DRAINAGE, STRIPING,	SIGNAL & BRIDGE REVS	DESCRIPTION
		33	2	-			MARK
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PREPARED UNDER THE RESPONSIBLE CHARGE

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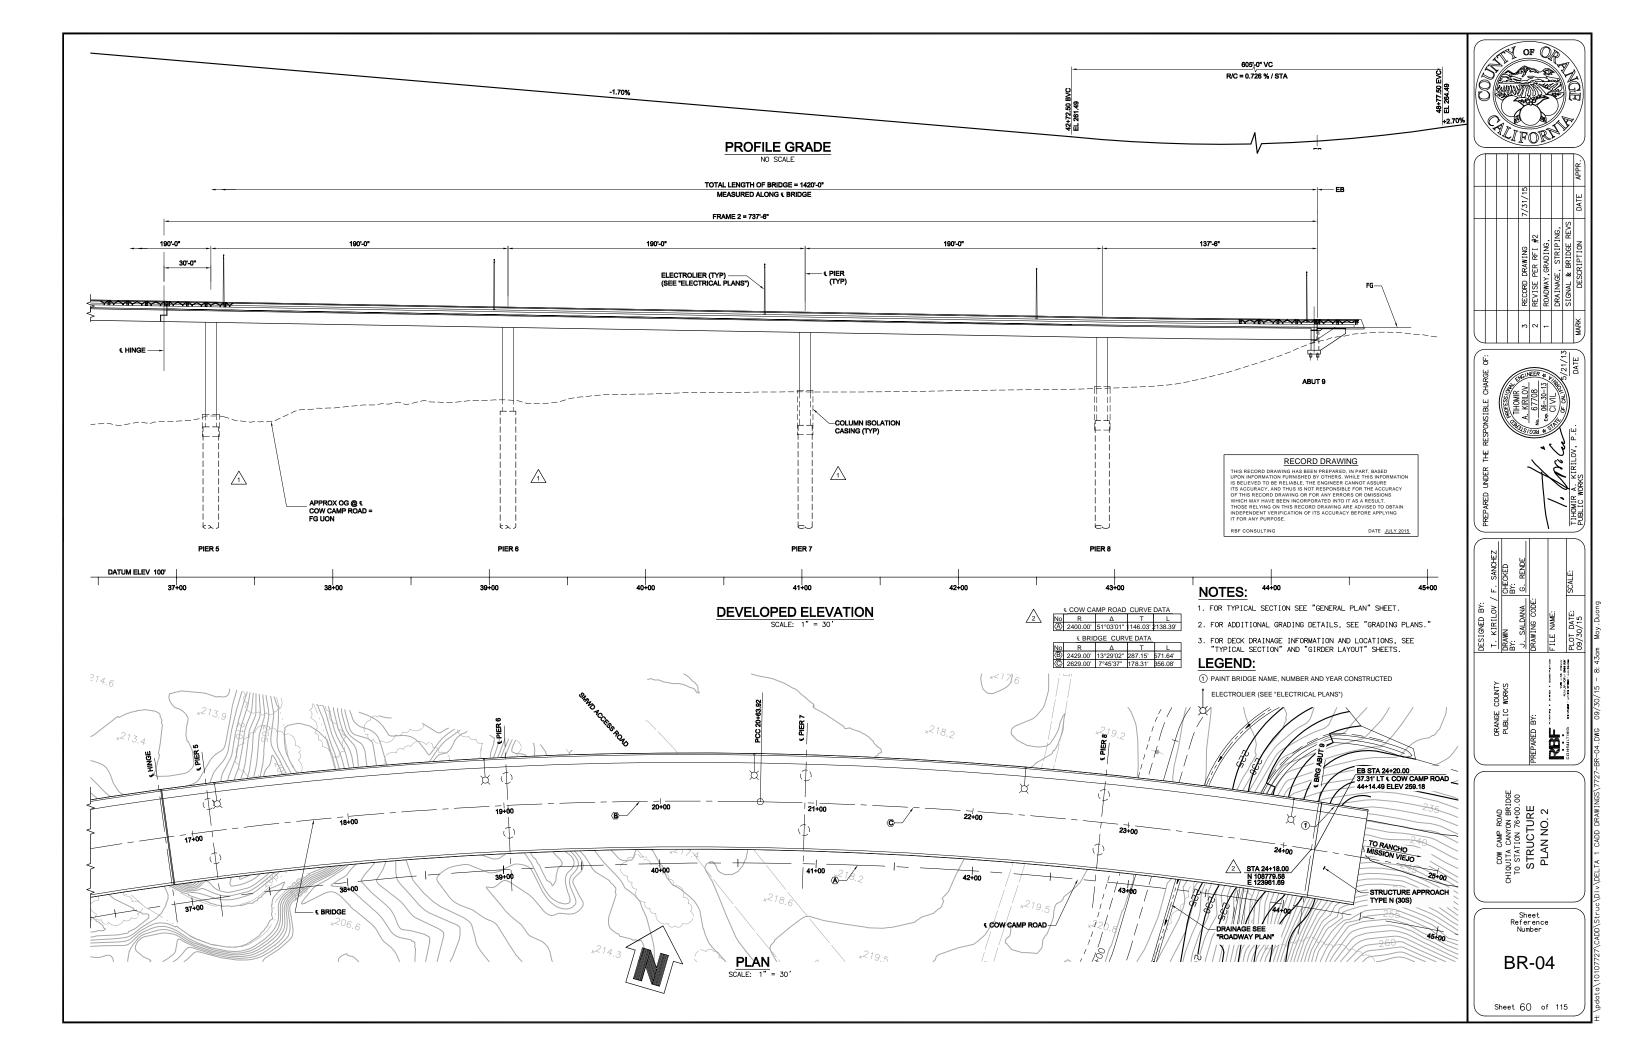
ORANGE COUNTY	T. KIRILOV / F. SANCHEZ	F. SANCHEZ
PUBLIC WORKS	DRAWN BY:	CHECKED BY:
	J. SALDANA	G. RENDE
PREPARED BY:	DRAWING CODE:	
HERMONEUM HOUSE BANKS	FILE NAME:	
CONSULTING ***Made - Fox 4-01/2 day - AAA 74 day	PLOT DATE:	SCALE:


TO STATION 76+00.00 STRUCTURE PLAN NO. 1

Sheet eference Number

BR-03

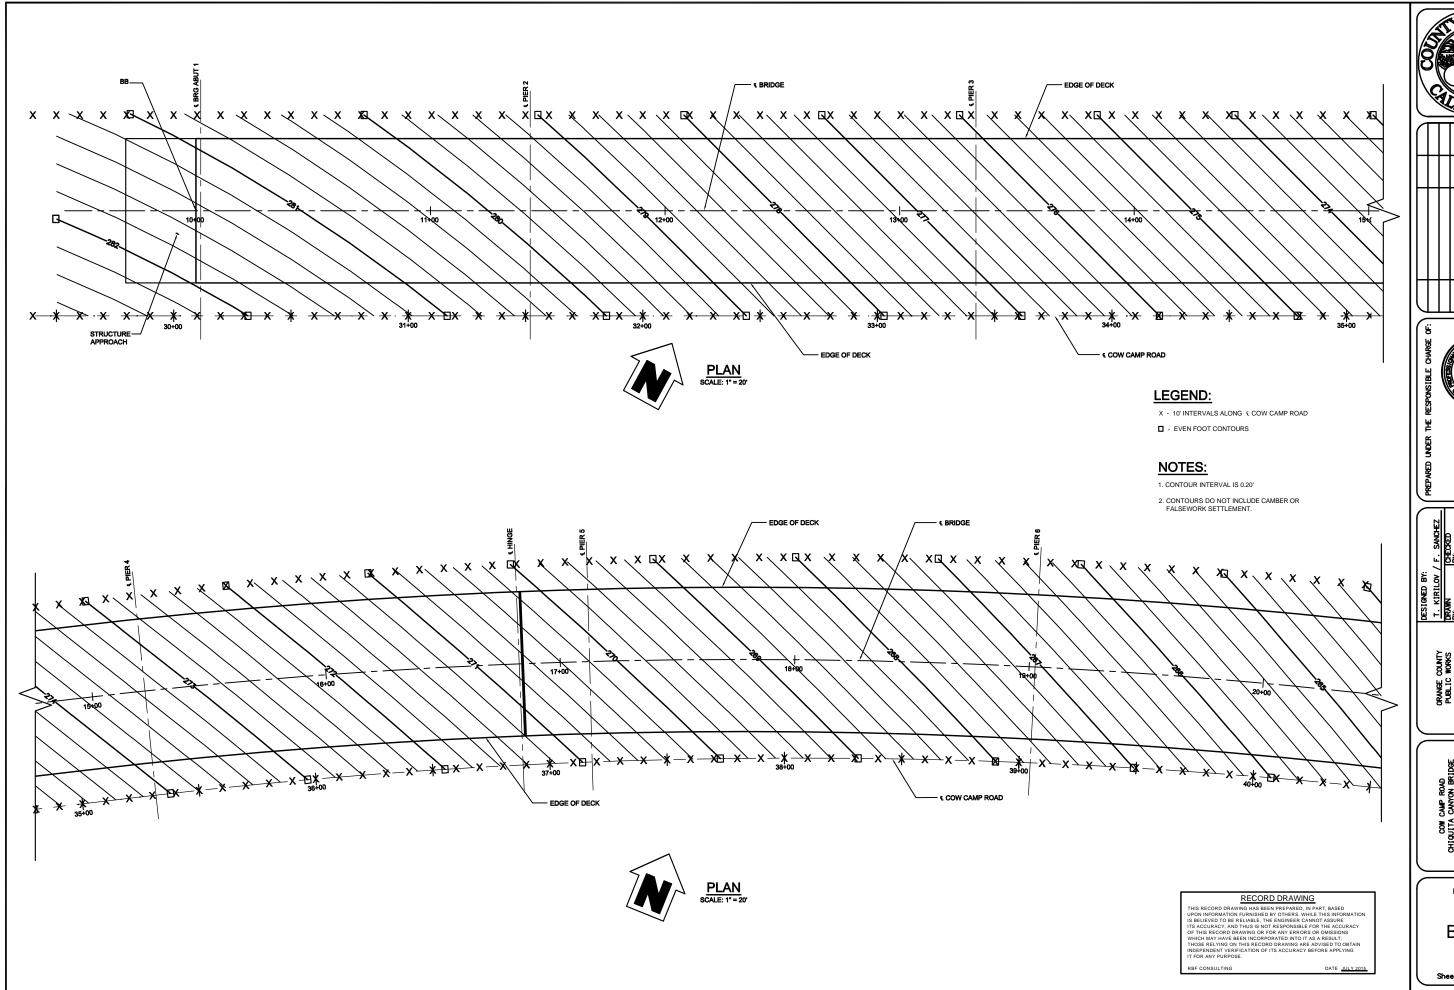Sheet 59 of 115










CONSULTING

COW CAMP ROAD
CHIQUITA CANYON BRIDGE
TO STATION 76+00.00
DECK CONTOURS NO. 1

Sheet Reference Number

BR-05

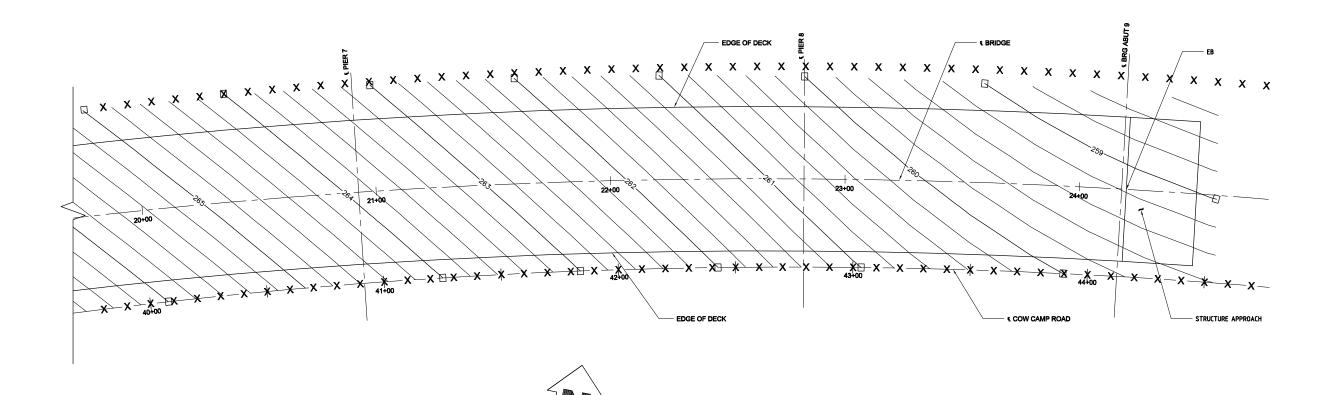Sheet 61 of 115



LEGEND:

- X 10' INTERVALS ALONG & COW CAMP ROAD
- ☐ EVEN FOOT CONTOURS

NOTES:

- 1. CONTOUR INTERVAL IS 0.20'
- CONTOURS DO NOT INCLUDE CAMBER OR FALSEWORK SETTLEMENT.

RECORD DRAWING

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RBF CONSULTING

DATE JULY 2015








BLIC WORKS DRAWN DRAWN U. SALDANA BY: DRAWING CODE:	<u> </u>	DESIGNED BY:	
C WORKS		r. KIRILOV / F	F. SANCHEZ
JAC SEE OLD TO CHANGE MINISTRACIONEN DE HOUMES DE EM-		ZW.	CHECKED BY:
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	HELICIPALISHED & HEALTH & DANIES AND	ILE NAME:	
	_		SCALE:
	1 1 1 1 1 1 1		

BR-06

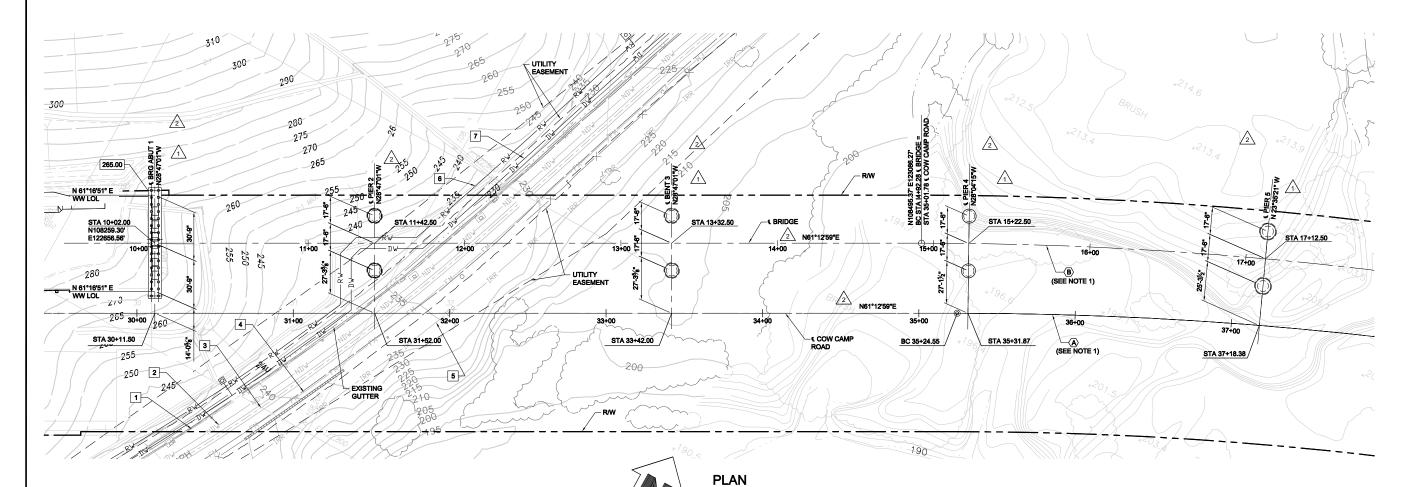Sheet 62 of 115



EXISTING UTILITY LINES:

- 1 20" WATER, PROTECT IN PLACE
- 2 16" NON-DOMESTIC WATER, PROTECT IN PLACE
- 3 42" SEWER, PROTECT IN PLACE
- 4 16" SEWER, FORCED MAIN, PROTECT IN PLACE
- 5 8" WATER IRRIGATION, RMV, PROTECT IN PLACE

NEW UTILITY LINES:

- 6 30" RECLAIMED WATER, SMWD, PROTECT IN PLACE
- 7 24" WATER, SMWD, PROTECT IN PLACE

			PILE	<u>DATA</u>			
LOCATION	PILE TYPE	CUT-OFF NOMINAL RESISTANCE ELEVATION COMPRESSION TENSIO (FT) (KIPS) (KIPS)			DESIGN TIP ELEVATION (FT)	SPECIFIED TIP ELEVATION (FT)	
ABUTMENT 1	18" Ø CIDH	265.25	220	0	234.25 (a)	234	
PIER 2	108" Ø CIDH	214	5790	0	181 (a), 171 (d)	171	
PIER 3	108" Ø CIDH	194	6130 (1)	0	105 (a)	105	
PIER 4	108" Ø CIDH	191	6080	0	102 (a)	102	
PIER 5	120" Ø CIDH	196	7580 (1)	0	80 (a)	80	
PIER 6	120" Ø CIDH	206	6780 (1)	0	102 (a)	102	
PIER 7	108" Ø CIDH	197	7850 (1)	0	83 (a)	83	
PIER 8	108" Ø CIDH	200	5650	0	138 (a)	138	
ABUTMENT 9	18" Ø CIDH	242.75	220	0	211.75 (a)	211	

- a) COMPRESSION b) TENSION c) SETTLEMENT d) LATERAL LOAD

- NOTES:

 1) VALUES INCLUDE SEISMICALLY-INDUCED DOWNDRAG OF 2030 KIPS FOR PIER 3, 3280 KIPS FOR PIER 5, 2780 KIPS FOR PIER 6, AND 3890 KIPS FOR PIER 7.

 2) ELEVATION OF BOTTOM OF LIQUEFIABLE ZONE AT PIER 3 IS 154 FT, AT PIER 4 IS 147 FT, AT PIER 5 IS 124 FT, AT PIER 6 IS 145 FT, AND AT PIER 7 IS 126 FT.

 $\sqrt{1}$

BASIS OF BEARINGS:
THE BASIS OF BEARINGS FOR THIS PROJECT IS THE CALIFORNIA CORDINATE SYSTEM (CCS83), ZONE VI,
NADS (EPOCH 1991.35), AS DETERMINED LOCALLY BY A LINE BETWEEN
CONTINUOUS GLOBAL POSITIONING STATIONS (CGPS) SBCC AND TRAK BEING N80°31'33"W AS DERIVED
FROM GEODETIC VALUES PUBLISHED AND ON FILE IN THE OFFICE OF THE ORANGE COUNTY
SURVEYOR.

BENCHMARK:

AP-02-99 (NGVD29) ELEVATION: 235.793'
(NAVD88) ELEVATION: 238.113'
FOUND 3 - 3'," DOS ALUMINUM BENCHMARK DISK STAMPED "AP-02-99", SET IN THE NORTHEASTERLY
CORNER OF A CONCRETE BRIDGE DECK. MONUMENT IS LOCATED IN THE NORTHEASTERLY CORNER OF ANTONIO PARKWAY AND ITS OVERCROSSING OF SAN JUAN CREEK.

HYDROLOGIC SUMMARY DRAINAGE AREA: <u>7</u> SQUARE MILES	
FREQUENCY (YEARS)	SPF 100
DISCHARGE (CUBIC FEET PER SECOND)	5,600
WATER SURFACE (ELEVATION AT BRIDGE)	205
MAXIMUM CHANNEL DEPTH (FEET)	13.44
TOP WIDTH (FEET)	485.31

SPF = STANDARD PROJECT FLOOD

RECORD DRAWING

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DATE JULY 2015

LEGEND:

XXXXX BOTTOM OF FOOTING ELEVATION

18" DIA CAST-IN-DRILLED-HOLE CONCRETE PILE

LARGE DIA CAST-IN-DRILLED-HOLE CONCRETE PILE

COLUMN ISOLATION CASING


NOTES:

- 1. FOR CURVE DATA, SEE "STRUCTURE PLAN NO. 1" SHEET.
- 2. FOR ABUTMENT PILE LAYOUT, SEE "ABUTMENT PILE LAYOUT" SHEET.
- 3. THE CONTRACTOR SHALL POTHOLE ALL EXISTING UTILITIES WITHIN THE CONSTRUCTION ZONE TO VERIFY EXISTING UTILITY LOCATIONS.

_		1	_		1	
	F. SANCHEZ	CHECKED BY:	G. RENDE			SCALE:
	T. KIRILOV / F. SANCHEZ	DRAWN BY:	J. SALDANA	DRAWING CODE:	FILE NAME:	PLOT DATE:
	UNTY	RKS			напачанная в нам	TOTAL STATE STATE OF THE STATE

BR-07

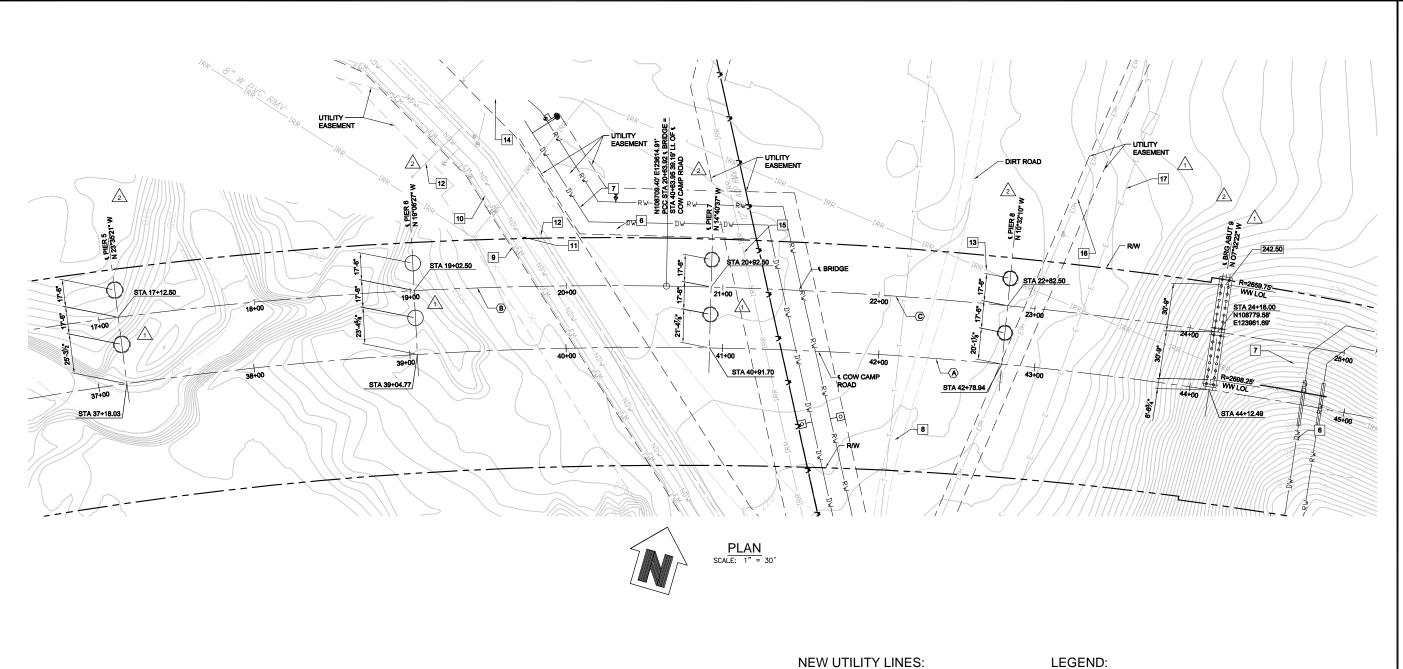Sheet 63 of 115



6 30" RECLAIMED WATER

7 24" WATER

8 12" WATER IRRIGATION

EXISTING UTILITY LINES:

9 10" SEWER, FORCED MAIN, PROTECT IN PLACE

10 16" SEWER, FORCED MAIN, PROTECT IN PLACE

11 16" NON-DOMESTIC WATER, PROTECT IN PLACE

12 66" WATER, PROTECT IN PLACE

13 8" WATER IRRIGATION, RMV, TO BE RELOCATED

14 12" WATER, RMV, PROTECT IN PLACE

15 12" WT ACP RMV, TO BE RELOCATED

16 ELECTRICAL OVERHEAD, TO BE RELOCATED

17 12 KV ELECTRICAL LINE, PROTECT IN PLACE

XXX.XXX BOTTOM OF FOOTING ELEVATION

18" DIA CAST-IN-DRILLED-HOLE CONCRETE PILE

LARGE DIA CAST-IN-DRILLED-HOLE CONCRETE PILE

COLUMN ISOLATION CASING

NOTES:

1. FOR CURVE DATA, SEE "STRUCTURE PLAN NO. 2" SHEET.

2. FOR ABUTMENT PILE LAYOUT, SEE "ABUTMENT PILE LAYOUT" SHEET.

3. FOR PILE DATA TABLE, BASIS OF BEARINGS, AND BENCH MARK, SEE "FOUNDATION PLAN NO. 1" SHEET.

RECORD DRAWING

DATE JULY 2015

	7/31/15				
	RECORD DRAWING	REVISE PER RFI #2	ROADWAY,GRADING,	DRAINAGE, STRIPING,	SIGNAL & BRIDGE REVS
	3	2	1		




LNT	I. KIKILOV / F. SANCHEZ	F. SANCHEZ	
RKS	DRAWN BY:	CHECKED BY:	
	J. SALDANA	G. RENDE	
	DRAWING CODE:		
	FILE NAME:		
AND SOUTH SECURITY SECURITY			
	153	SCALE:	
	10/01/15		

Sheet Reference Number

BR-08

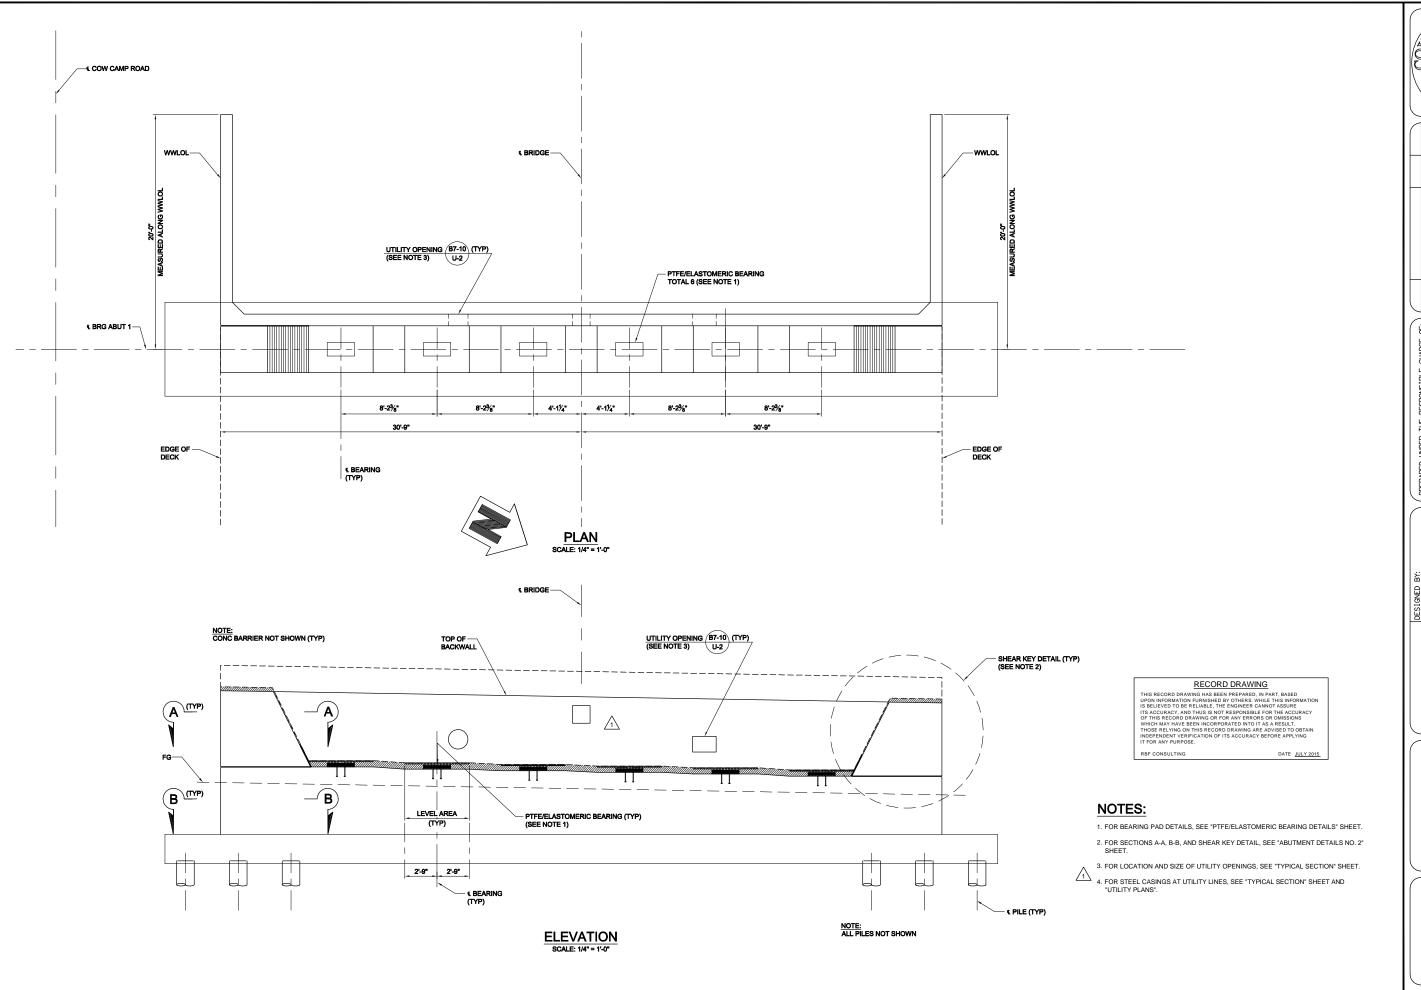Sheet 64 of 115





						qqq
		7/31/15				
		RECORD DRAWING	ROADWAY,GRADING,	DRAINAGE, STRIPING,	SIGNAL & BRIDGE REVS	
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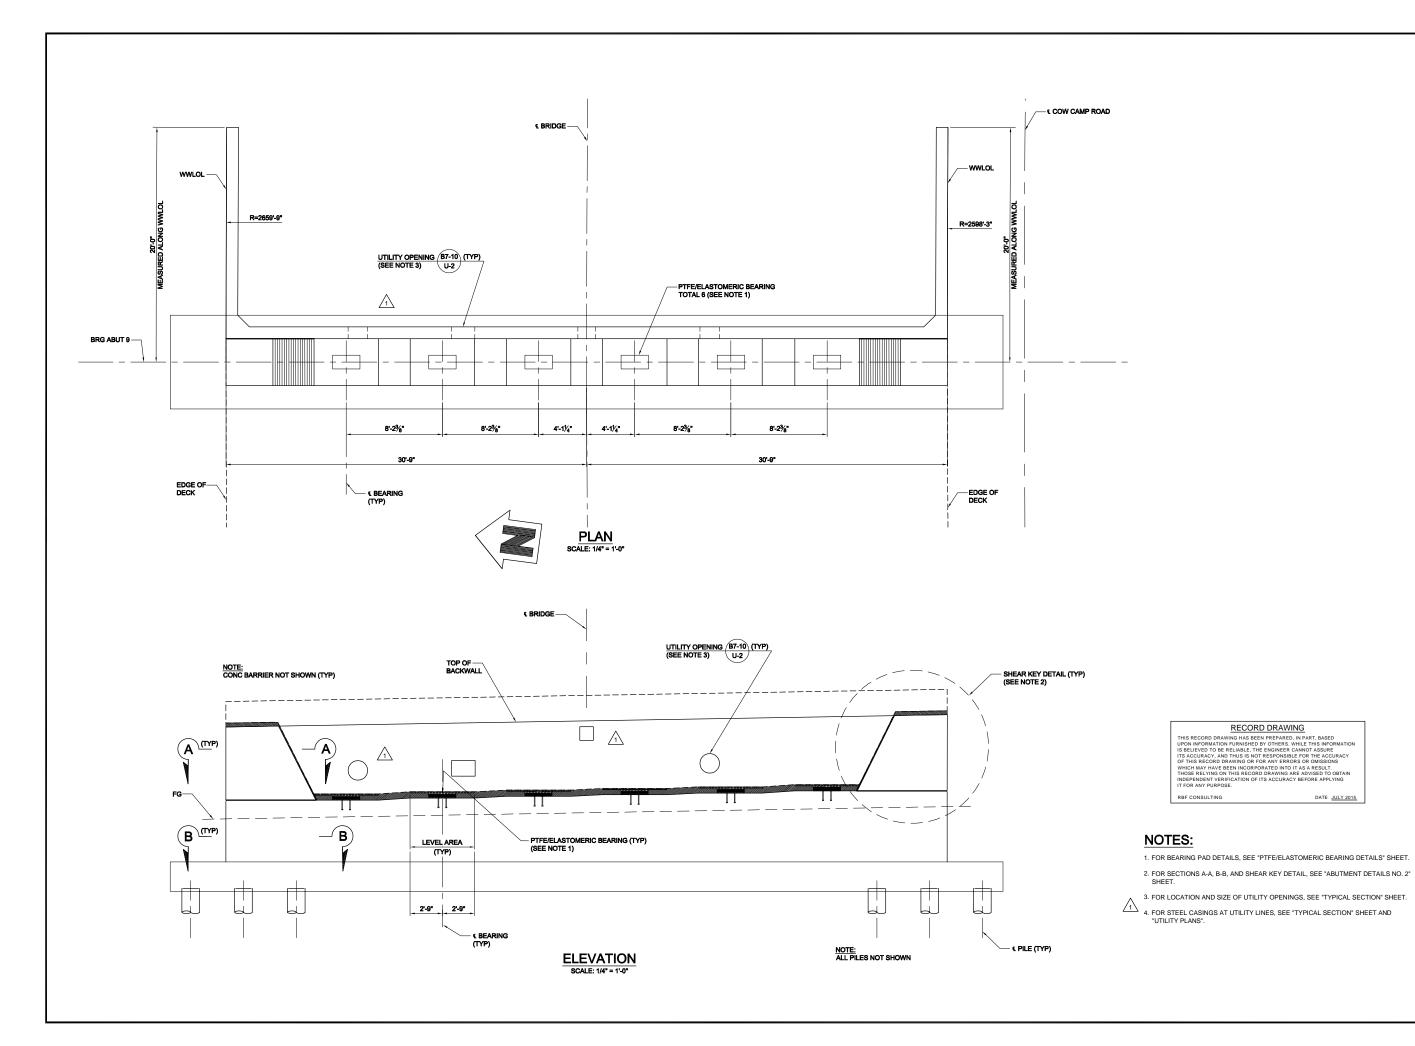
ORANGE COUNTY	T. KIRILOV / F. SANCHE	F. SANCHE
PUBLIC WORKS	DRAWN BY:	CHECKED BY:
	J. SALDANA	G. RENDE
PREPARED BY:	DRAWING CODE:	
MELITERATION HEATER BANKS	FILE NAME:	
CONSULTING STANSON STANSON BUILDINGS	DI OT DATE.	SCAL F:

HIGGITA CANTON BRIDGE
TO STATION 76+00.00
ABUTMENT 1
LAYOUT

Sheet Reference Number

BR-09

Sheet **65** of 115





						APPR
		7/31/15				DATE
		RECORD DRAWING	ROADWAY, GRADING,	DRAINAGE, STRIPING,	SIGNAL & BRIDGE REVS	NULLEIBUSEU
		3	-			MARK





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DATE JULY 2015

BR-10

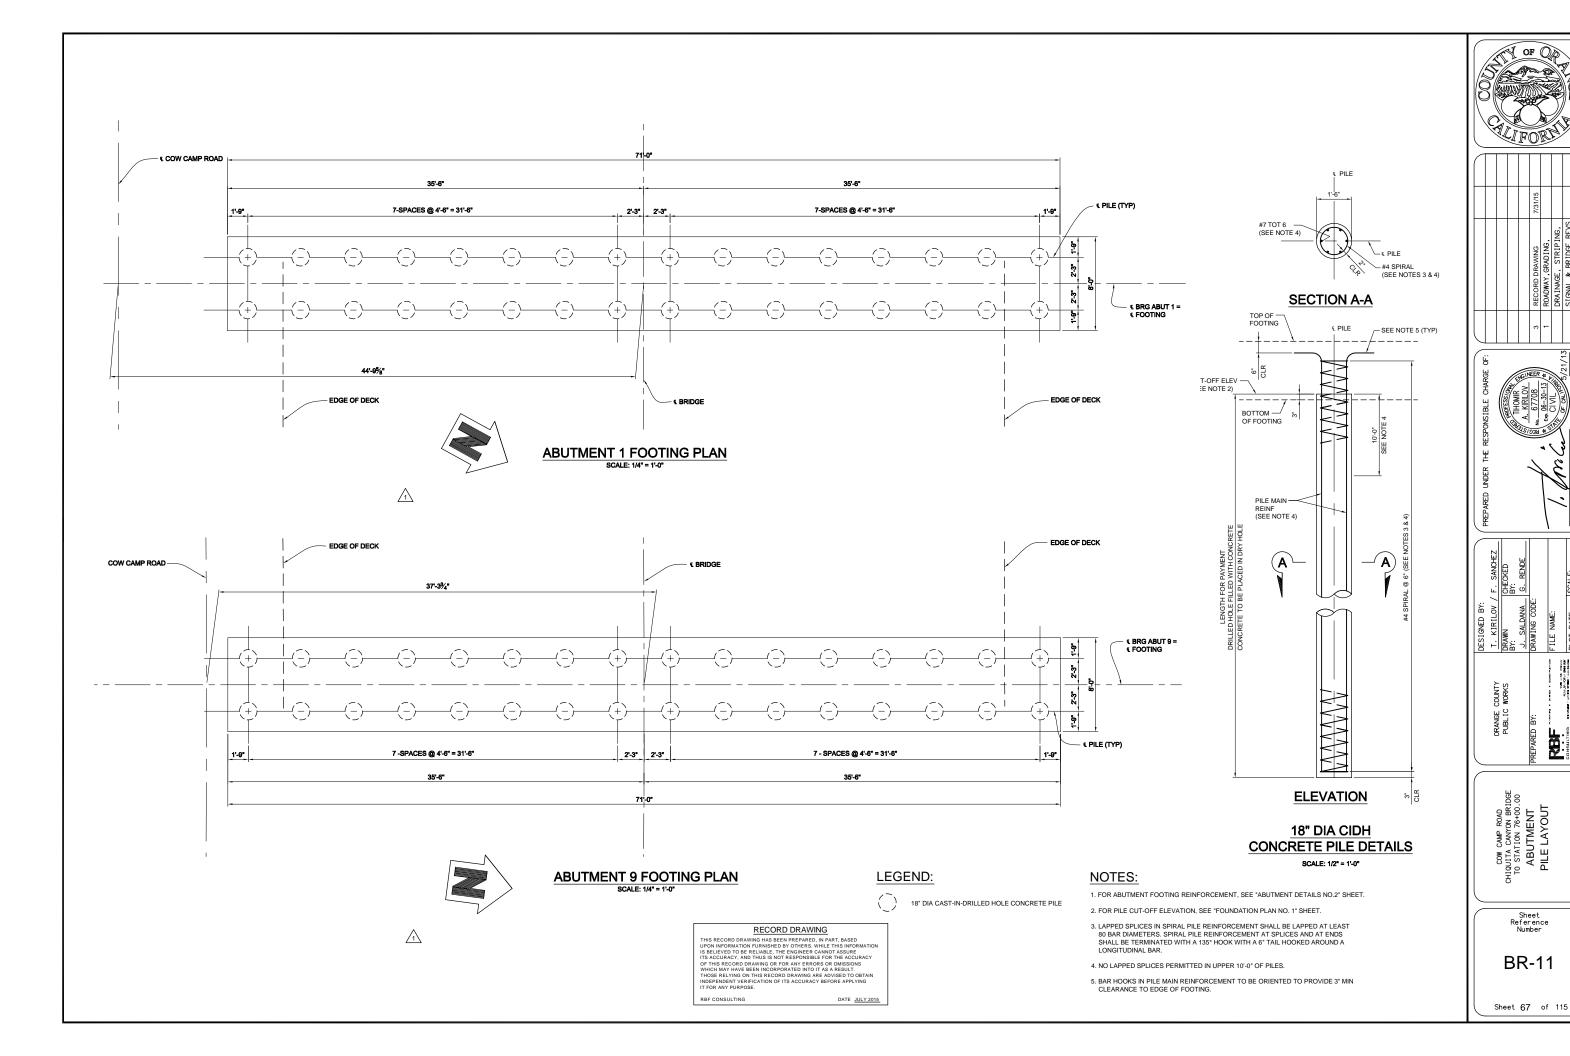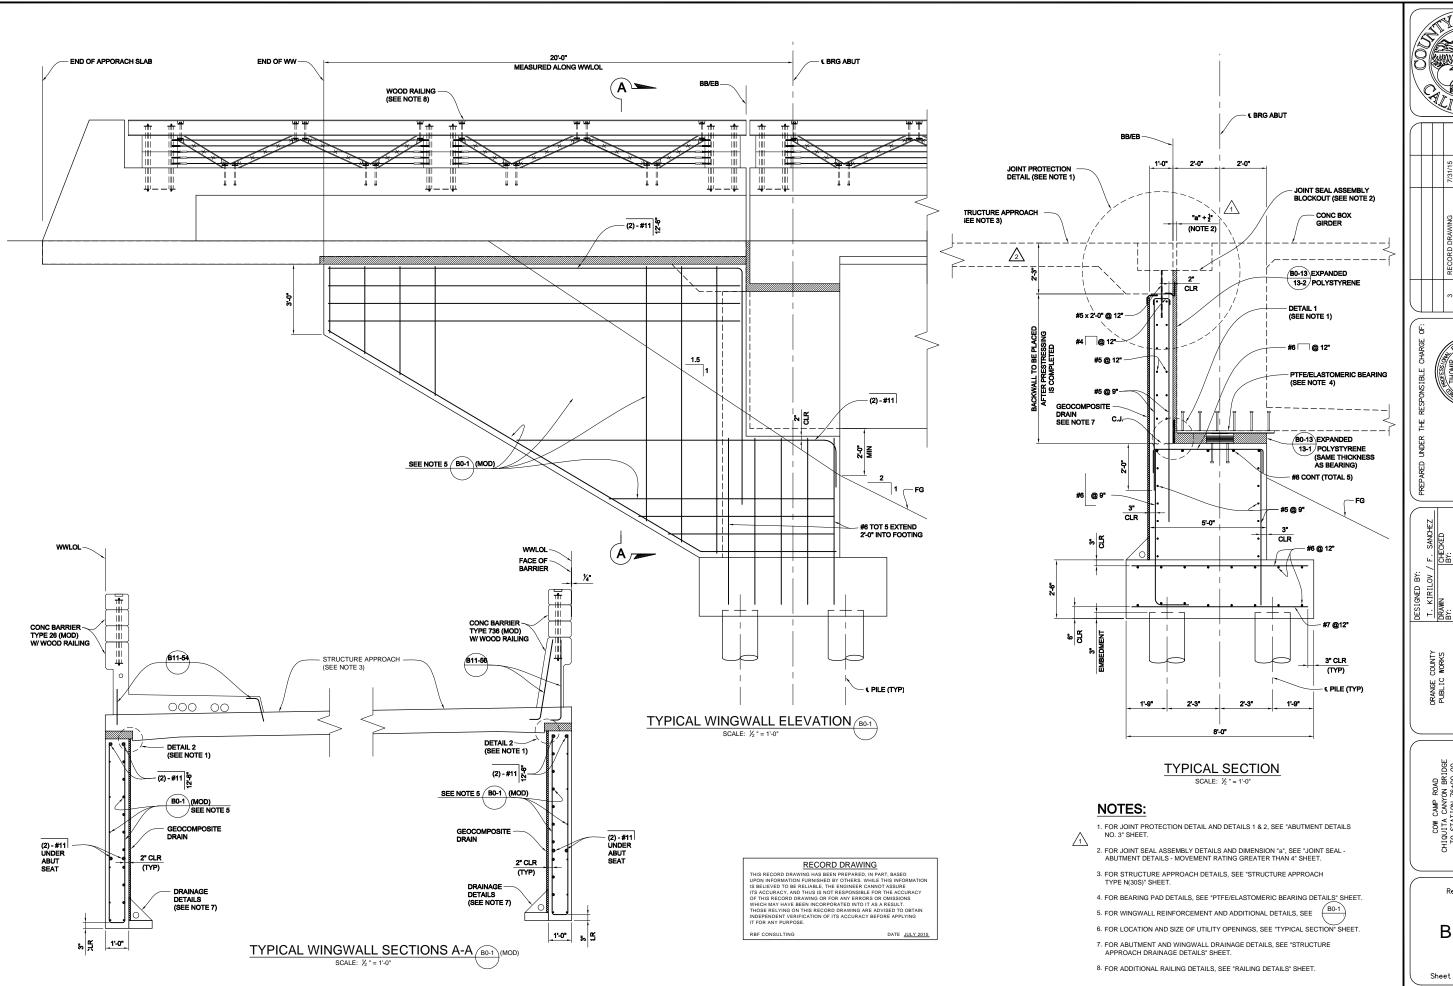Sheet 66 of 115






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COW CAMP ROAD CHIQUITA CANYON BRIDGE TO STATION 76+00.00 ABUTMENT DETAILS NO. 1


Sheet eference

BR-12

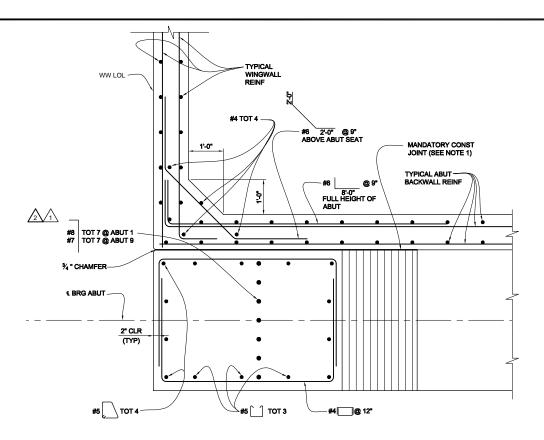Sheet 68 of 115




SECTION A-A

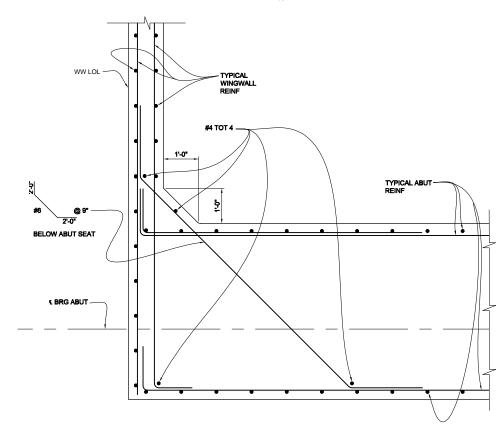

SECTION B-B SCALE: 3/4 " = 1'-0"

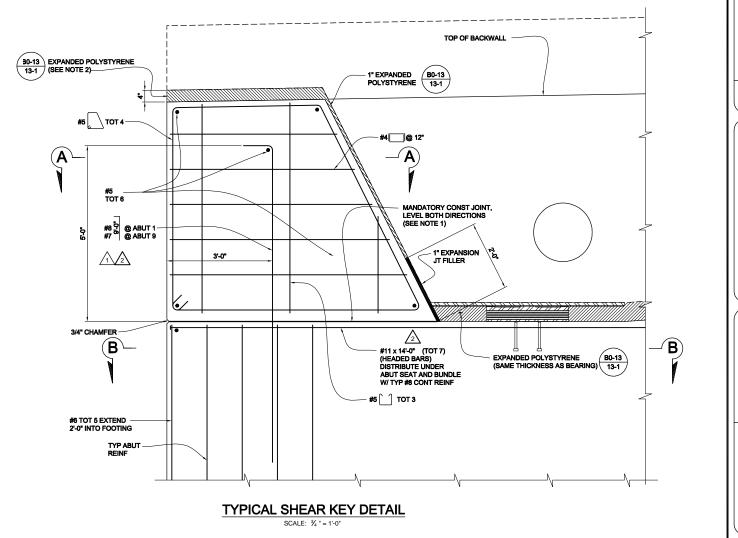NOTE: FOR INFORMATION NOT



RECORD DRAWING

THIS RECORD DRAWING HAS BEEN PREPARED, IN PART, BASED UPON INFORMATION FURNISHED BY OTHERS, WHILE THIS INFORMATION FURNISHED BY OTHERS, WHILE THIS INFORMATION FURNISHED BY OTHERS, WHILE THIS INFORMATION FURNISHED FOR THE ACCURACY, AND THUS IS NOT RESPONSIBLE FOR THE ACCURACY WHICH MAY HAVE BEEN INCORPORATED INFOLT TO A RESULT. THOSE RELYING ON THIS RECORD DRAWING ARE ADVISED TO OSTAIN INDEPENDENT VERIFICATION OF ITS ACCURACY BEFORE APPLYING IT FOR ANY PURPOSE.

RBF CONSULTING

DATE JULY 2015

NOTES:

- 1. MANDATORY JOINT SURFACE TO BE SMOOTH FINISHED AND LINED WITH 15 POUND CONSTRUCTION PAPER.
- 2. OUTER 6" OF EXPANDED POLYSTYRENE TO BE REMOVED AFTER CONSTRUCTION.

		OF	OR SI	
CA CA	LII		RY	


	RECORD DRAWING	7/31/15	
	REVISIONS AFTER		
	BID SET DATED 05-01-2013		
	ROADWAY, GRADING,		
	DRAINAGE, STRIPING,		
	SIGNAL & BRIDGE REVS		
AGVM	TOTAL COOL	7++C	dady




r . SANCHEZ	CHECKED BY:	G. RENDE			SCALE:
I. KIKILOV / F. SANCHEZ	DRAWN BY:	J. SALDANA	DRAWING CODE:	FILE NAME:	PLOT DATE:
ORANGE COUNTY	PUBLIC WORKS		PREPARED BY:	MOUNTAINMENT HOUSE COMMENT HOUSE	CONSULTING SOME SERVICE CONTINUES CO

BR-13

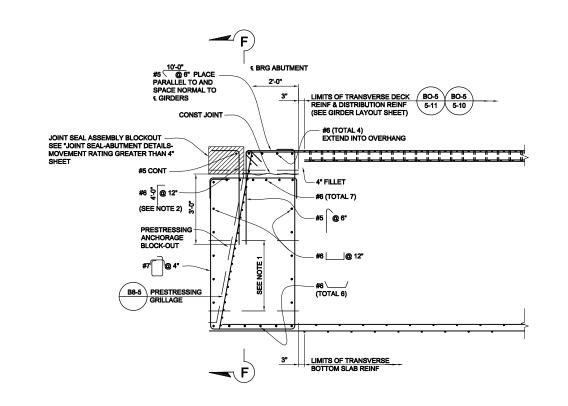Sheet 69 of 115



END DIAPHRAGM TYPICAL SECTION

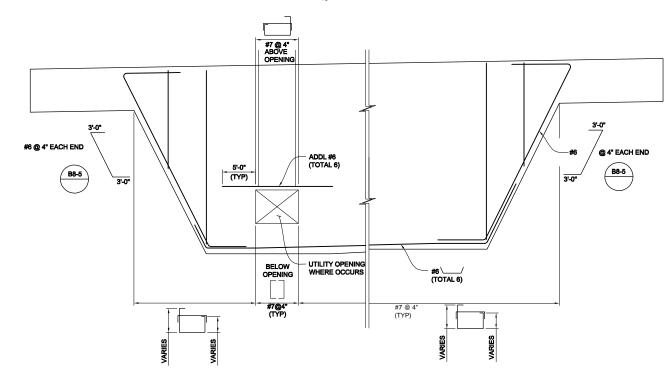

SECTION F-F

SCALE: 1/2 " = 1'-0"


RECORD DRAWING

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BB OR EB BLOCKOUT FOR JOINT SEAL ASSEMBLY "a"+ ½" SEE NOTE 3 STRUCTURE APPROACH SLAB 3" BONDING ON SMOOTH FINISH - ALTERNATIVE 1
TEMPORARY
BUMPER WITH
INSERTS ಕ್ಕ∱ BONDING %" x 1-0"
NEOPRENE STRIP.
PLACE PRIOR TO
BACKFILLING THE
ABUTMENT BACKWALL
AND INSTALLING THE
TEMPORARY BUMPER.
(FOLD NEOPRENE
INTO CHAMFER) - EXPANDED POLYSTYRENE ABUTMENT BACKWALL GEOCOMPOSITE DRAIN

JOINT PROTECTION DETAIL

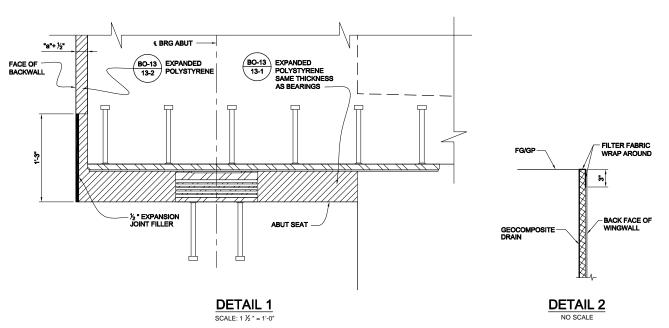SCALE: 1 1/2 " = 1'-0"



NOTES:

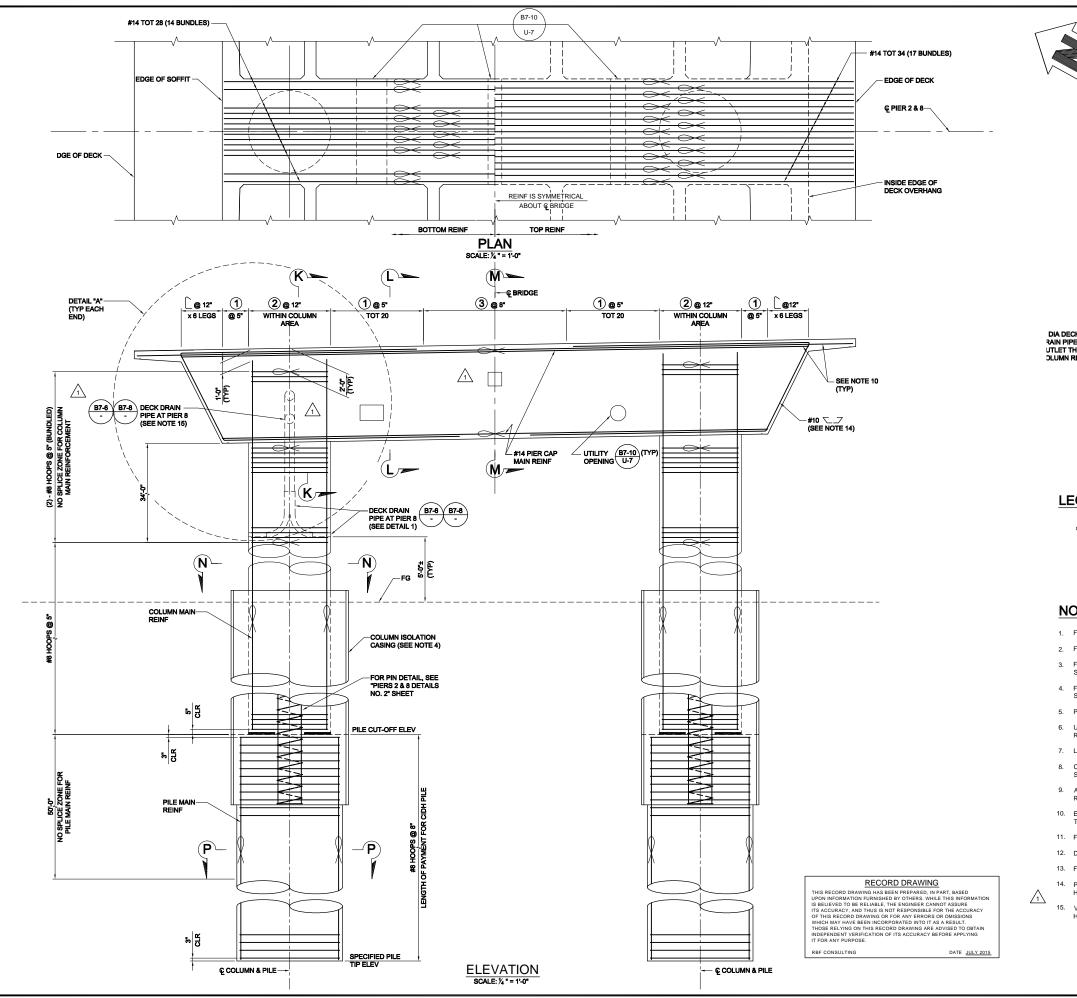
- 1. FOR LOCATION AND SIZE OF UTILITY OPENINGS, SEE "TYPICAL SECTION" SHEET.
- REINFORCING BARS MAY BE ADJUSTED, AS NECESSARY, TO ACCOMMODATE INSTALLATION OF JOINT SEAL ASSEMBLY (UPON APPROVAL OF THE JOINT SEAL ASSEMBLY SHOP DRAWINGS AND AS DIRECTED BY THE ENGINEER).
- 3. FOR DIMENSION "8", SEE "JOINT SEAL-ABUTMENT DETAILS-MOVEMENT RATING GREATER THAN 4" SHEET.



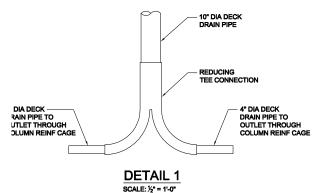
Sheet Reference Number

BR-14

Sheet 70 of XXX







LEGEND:

SUNDLED BARS

 \otimes STIRRUP CONFIGURATION NUMBER (SEE "TYPICAL PIER DETAILS NO. 1" SHEET)

NOTES:

- 1. FOR SECTION K K, L L, AND M M, SEE "PIERS 2 & 8 DETAILS NO. 1" SHEET.
- 2. FOR SECTIONS N N AND P P, SEE "PIERS 2 & 8 DETAILS NO. 2" SHEET.
- 3. FOR DETAIL "A" AND PIER CAP STIRRUP TABLE, SEE "TYPICAL PIER DETAILS NO. 1"
- FOR COLUMN ISOLATION CASING DETAILS, SEE "TYPICAL PIER DETAILS NO. 2" SHEET.
- 5. PLACE STIRRUPS NORMAL TO AND SPACE ALONG CIPIER.
- 6. ULTIMATE SPLICES ARE PERMITTED IN THE MIDDLE OF THE TOP CAP MAIN REINFORCING. NO SPLICES PERMITTED IN THE BOTTOM CAP MAIN REINFORCING.
- 7. LAPPED SPLICES ARE NOT PERMITTED IN COLUMN AND PILE REINF.
- 8. COLUMN AND PILE MAIN REINF, WHERE PERMITTED, SHALL MEET THE "ULTIMATE SPLICE" REQUIREMENTS.
- ALL HOOPS SHALL BE BUTT WELDED AND SHALL MEET THE "ULTIMATE SPLICE" REQUIREMENTS.
- 10. EXTEND PIER CAP TOP BUNDLE MAIN REINF INTO DECK OVERHANG SLAB.
 TERMINATE BOTTOM BUNDLE REINF AT INSIDE EDGE OF DECK OVERHANG
- 11. FOR LOCATION AND SIZE OF UTILITY OPENINGS, SEE "TYPICAL SECTION" SHEET.
- 12. DETAILS ARE SIMILAR AT BOTH COLUMNS.
- 13. FOR GROUND WATER ELEVATIONS, SEE BRIDGE FOUNDATION REPORT.
- 14. PRESTRESSING DUCT LAYOUT WITHIN PIER CAP MAY BE ADJUSTED BY 3" MAX HORIZONTALLY TO CLEAR #10 BARS.
- 15. VERTICAL HIGH FLOW PIPE LOCATION MAY BE ADJSUTED TO CLEAR CONTINUOUS HORIZONTAL LOW FLOW PIPE THROUGH COLUMN.



						APP
		7/31/15				DATF
		RECORD DRAWING	ROADWAY,GRADING,	DRAINAGE, STRIPING,	SIGNAL & BRIDGE REVS	NULLGLAUSEU
		3	1			MARK





ORANGE COUNTY	T. KIRILOV / F. SANCHEZ	F. SANCHEZ
PUBLIC WORKS	DRAWN BY:	CHECKED BY:
	J. SALDANA	G. RENDE
PREPARED BY:	DRAWING CODE:	
HELITATIONEER & HEARING & EMILIARY AND	FILE NAME:	
MEDICAN - NEW KIDA NE - PROMING - BALLINGS OF BOOK	PLOT DATE:	SCALE:

COW CAMP ROAD
CHIQUITA CANYON BRIDGE
TO STATION 76+00.00
PIERS 2 & 8 LAYOUT

BR-15

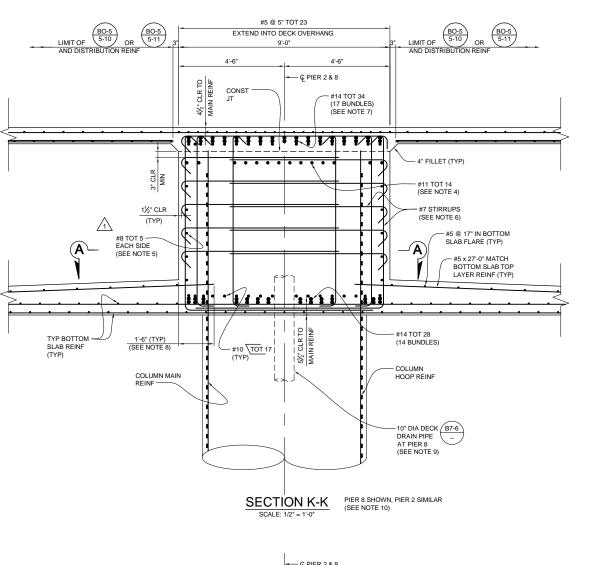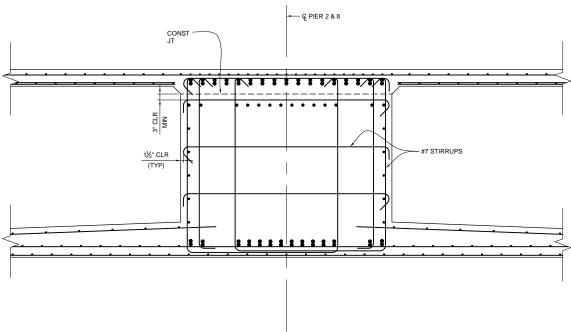Sheet **71** of 115






NOTE: FOR INFORMATION NOT SHOWN, SEE SECTION K-K

SECTION M-M
SCALE: 1/2" = 1'-0"

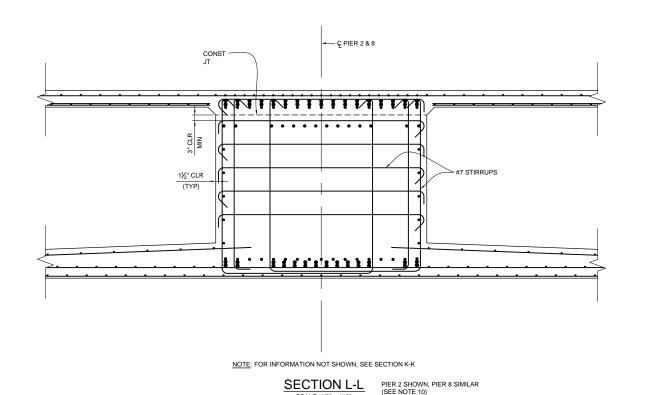
PIER 2 SHOWN, PIER 8 SIMILAR
(SEE NOTE 10)



SCALE: 1/2" = 1'-0"

NOTES:

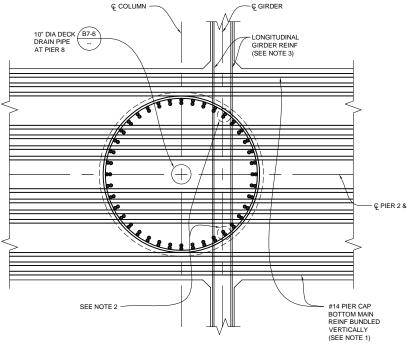- PRIOR TO COLUMN CONCRETE PLACEMENT, THE CONTRACTOR SHALL ARRANGE,
 ROTATE, AND SPACE COLUMN REINFORCING CAGE TO ENSURE PLACEMENT OF PIER
 CAP BOTTOM MAIN REINF AS SHOWN.
- MAXIMUM 4 LONGITUDINAL COLUMN MAIN REINF BARS MAY BE CUT BY 1'-3" TO CLEAR P/S DUCTS.
- 3. LONGITUDINAL GIRDER REINF MAY BE ADJUSTED TO CLEAR COLUMN MAIN REINF.
- 4. REINF MAY BE BENT OR LOWERED TO CLEAR P/S DUCTS.
- SIDE FACE REINF SHALL BE SPACED EQUALLY AT 12" MAX AND MAY BE DISCONTINUOUS AT UTILITY OPENINGS.
- 6. FOR PIER CAP STIRRUP CONFIGURATION, SEE "TYPICAL PIER DETAILS No. 1" SHEET.
- 7. EXTEND PIER CAP TOP BUNDLE MAIN REINF INTO DECK OVERHANG SLAB. TERMINATE BOTTOM BUNDLE REINF AT INSIDE EDGE OF DECK OVERHANG.
- 8. TERMINATE TYPICAL SOFFIT TOP LAYER TRANSVERSE REINF AT FACE OF PIER CAP. DISTRIBUTE TYPICAL SOFFIT BOTTOM LAYER TRANSVERSE REINF INTO THE PIER CAP.
- TYPICAL SOFFIT BOTTOM LAYER TRANSVERSE REINF MAY BE TERMINATED TO CLEAR DRAINAGE PIPE.
- 10. BOTTOM PIER CAP REINF IN PIER 8 WITH DRAINAGE PIPE SHALL BE DISTRIBUTED AS SHOWN IN SECTIONS K-K AND A-A. BOTTOM PIER CAP REINF IN PIER 2 SHALL BE DISTRIBUTED AS SHOWN IN SECTIONS L-L AND M-M.



 $\frac{ \mbox{SECTION A-A}}{\mbox{SCALE: } 1/2" = 1' \cdot 0"} \quad \mbox{PIER 8 SHOWN, PIER 2 SIMILAR} \\ (\mbox{SEE NOTE 10})$

RECORD DRAWING

THIS RECORD DRAWING HAS BEEN PREPARED, IN PART, BASED UPON INFORMATION FURNISHED BY OTHERS. WHILE THIS INFORMATION IS BELIEVED TO BE RELIABLE, THE ENGINEER CANNOT ASSURED ITS ACCURACY, AND THUS IS NOT RESPONSIBLE FOR THE ACCURACY OF THIS RECORD DRAWING OR FOR ANY ERRORS OR OMISSIONS WHICH MAY HAVE BEEN INCORPORATED INTO IT AS A RESULT. THOSE RELYMO ON THIS RECORD DRAWING ARE ADVISED TO OBTAIN MODEPHIDENT VERHIFICATION OF ITS ACCURACY BEFORE APPLYING IT FOR ANY PURPOSE.

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ATE JULY 2015





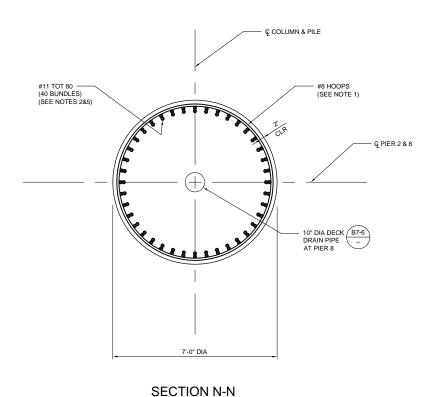
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T. KIRILOV / F. SANCHEZ	DRAWN BY:	J. SALDANA	DRAWING CODE:	FILE NAME:	PLOT DATE: 09/22/15	
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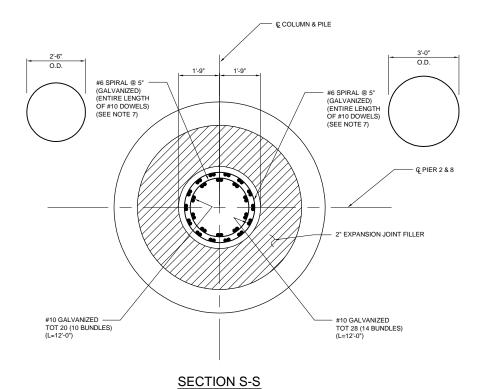
COW CAMP ROAD
CHIQUITA CANYON BRIDGE
TO STATION 78+00.00
PIERS 2 & 8
DETAILS NO. 1

Sheet Reference Number

BR-16

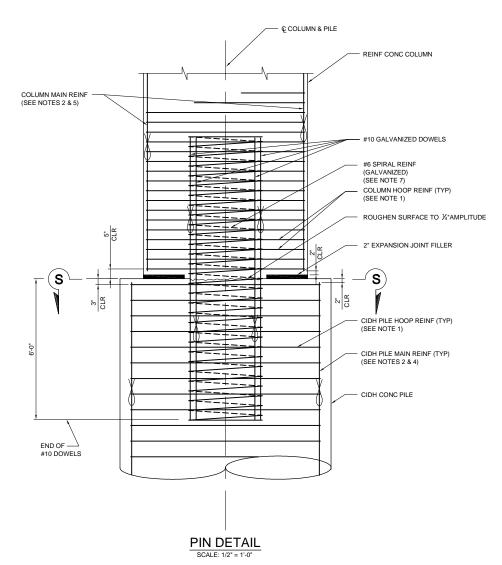
Sheet 72 of 115





€ COLUMN & PILE +8 HOOPS (SEE NOTE 1) (26 OUTER BARS 13 INNER BARS) (SEE NOTES 2 & 4) € PIER 2 & 8 INSPECTION TUBES (TOT 9) (SEE NOTES 6 & 8) 9'-0" DIA

SECTION P-P



LEGEND:

BUNDLED BARS

NOTES:

- 1. ALL HOOPS SHALL BE BUTT WELDED AND SHALL MEET THE "ULTIMATE SPLICE"
- 2. COLUMN AND PILE MAIN REINF, WHERE PERMITTED, SHALL MEET THE "ULTIMATE SPLICE" REQUIREMENTS.
- 3. LAPPED SPLICES ARE NOT PERMITTED IN COLUMN AND PILE REINFORCEMENT.
- 4. NO SPLICES PERMITTED IN PILE MAIN REINF WITHIN 50'-0" OF PILE CUT-OFF
- 5. ADJUST SPACING OF COLUMN MAIN REINF TO CLEAR DRAIN OUTLET.
- 6. ALLOW FOR 3" MIN CLEAR SPACING TO INSPECTION TUBES.
- SPIRAL REINF AT ENDS SHALL BE TERMINATED WITH A FULL HORIZONTAL TURN AROUND THE REBAR CAGE AND A 2-0* TAIL HOOKED AROUND A LONGITUDINAL BAR AND PASSING THROUGH THE CORE OF THE REBAR CAGE.
- 8. INSPECTION PIPES SHALL BE 40 PVC, AND SHALL CONFORM WITH THE PROVISIONS IN SECTION 49-3 OF CALTRANS STANDARD SPECIFICATIONS.

RECORD DRAWING

THIS RECORD DRAWING HAS SEEN PREPARED, IN PART, BASED UPON INFORMATION FURNISHED BY OTHERS, WHILE THIS INFORMATION IS BELIEVED TO BE RELIABLE, THE ENDINEER CANNOT ASSURE ITS ACCURACY, AND THUS IS NOT RESPONSIBLE FOR THE ACCURACY OF THIS RECORD DRAWING OF FOR ANY ERRORS OR OMISSIONS OF THIS RECORD DRAWING OF FOR ANY ERRORS OR OMISSIONS THOSE RELYING ON THIS RECORD DRAWING ARE ADVISED TO OBTAIN INDEPENDENT VERIFICATION OF ITS ACCURACY BEFORE APPLYING IT FOR ANY PURPOSE.

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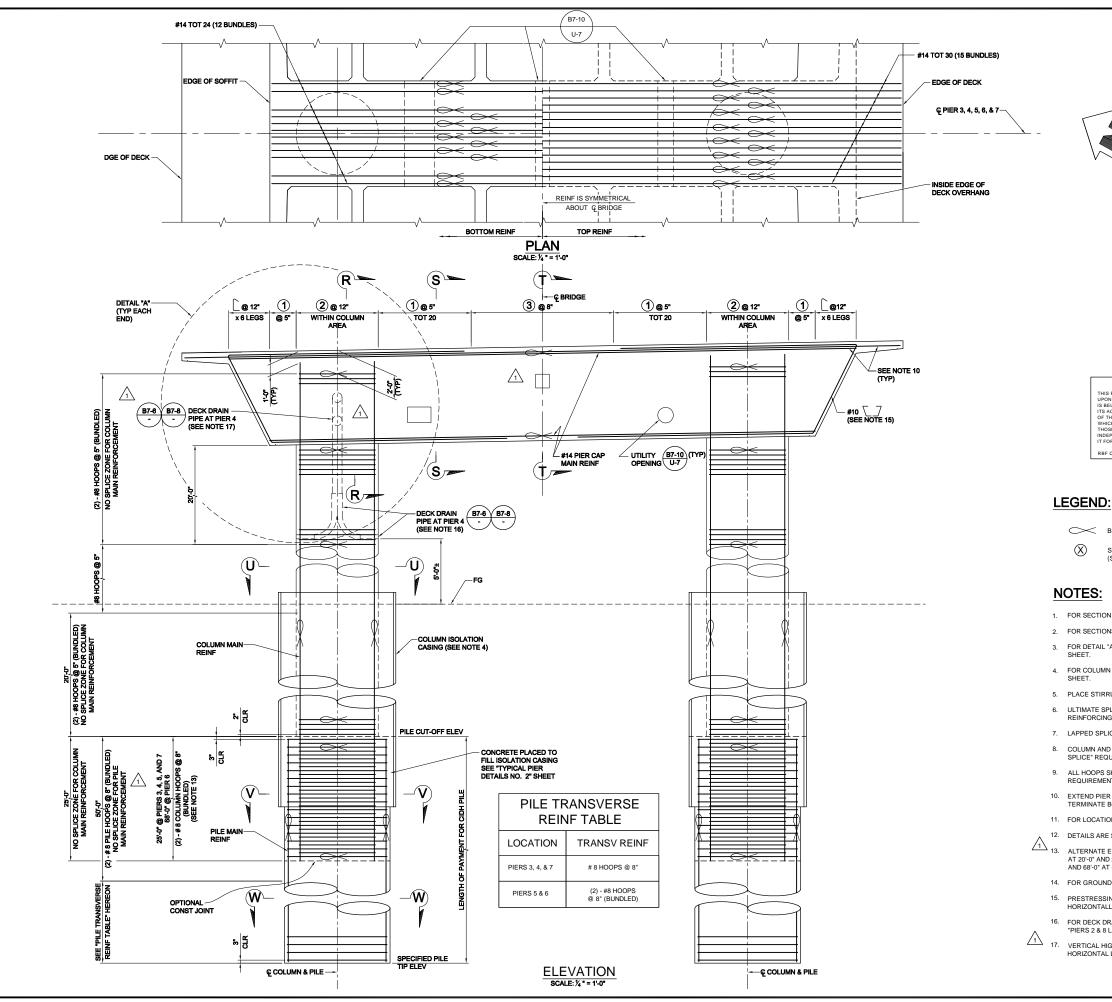


OPANGE COUNTY	T. KIRILOV / F. SANCHEZ	F. SANCHEZ
PUBLIC WORKS	DRAWN BY:	CHECKED BY:
	J. SALDANA	G. RENDE
REPARED BY:	DRAWING CODE:	
MODES OF STATE STATE OF STATE	FILE NAME:	
CONSULTING SEWAGE SERVICES CONSTRUCTION OF CON	PLOT DATE: 09/17/15	SCALE:

COW CAMP ROAD
CHIQUITA CANYON BRIDGE
TO STATION 76-00.00
PIERS 2 & 8
DETAILS NO. 2

BR-17

Sheet **73** of 115





RECORD DRAWING

THIS RECORD DRAWING HAS BEEN PREPARED, IN PART, BASED UPON INFORMATION FURNISHED BY OTHERS. WHILE THIS INFORMATION SELECTED TO BE RELIABLE, THE ENGINEER CANNOT ASSURE ITS ACCURACY, AND THUS IS NOT RESPONSIBLE FOR THE ACCURACY OF THIS RECORD DRAWING OF FOR MAY FERORS OR OMISSIONS WHICH MAY HAVE BEEN INCORPORATED INTO IT AS A RESULT. THOSE REL'ING ON THIS RECORD DRAWING ARE ADVISED TO OBTAIN INDEPENDENT VERRIFICATION OF ITS ACCURACY BEFORE APPLYING IT FOR ANY PURPOSE.

SUNDLED BARS

STIRRUP CONFIGURATION NUMBER (SEE "TYPICAL PIER DETAILS NO. 1" SHEET)

- 1. FOR SECTION R R, S S, AND T T, SEE "PIERS 3, 4, 5, 6, & 7 DETAILS NO. 1" SHEET.
- 2. FOR SECTIONS U U, V V, & W W SEE "PIERS 3, 4. 5, 6, & 7 DETAILS NO. 2" SHEET.
- FOR DETAIL "A" AND PIER CAP STIRRUP TABLE, SEE "TYPICAL PIER DETAILS NO. 1" SHEET.
- 4. FOR COLUMN ISOLATION CASING DETAILS, SEE "TYPICAL PIER DETAILS NO. 2"
- 5. PLACE STIRRUPS NORMAL TO AND SPACE ALONG CIPIER.
- 6. ULTIMATE SPLICES ARE PERMITTED IN THE MIDDLE OF THE TOP CAP MAIN
- 7. LAPPED SPLICES ARE NOT PERMITTED IN COLUMN AND PILE REINF.
- COLUMN AND PILE MAIN REINF, WHERE PERMITTED, SHALL MEET THE "ULTIMATE SPLICE" REQUIREMENTS.
- 9. ALL HOOPS SHALL BE BUTT WELDED AND SHALL MEET THE "ULTIMATE SPLICE"
- 10. EXTEND PIER CAP TOP BUNDLE MAIN REINF INTO DECK OVERHANG SLAB. TERMINATE BOTTOM BUNDLE REINF AT INSIDE EDGE OF DECK OVERHANG
- 11. FOR LOCATION AND SIZE OF UTILITY OPENINGS, SEE "TYPICAL SECTION" SHEET.
- 12. DETAILS ARE SIMILAR AT BOTH COLUMNS.
- 13. ALTERNATE EMBEDMENT LENGTH OF COLUMN MAIN REINF INTO PILE SHAFT
 AT 20-0" AND 25-0" AT PIERS 3, 4, 5, AND 7. ALTERNATE EMBEDMENT LENGTH AT 63-0"
 - 14. FOR GROUND WATER ELEVATIONS, SEE BRIDGE FOUNDATION REPORT.
 - 15. PRESTRESSING DUCT LAYOUT WITHIN PIER CAP MAY BE ADJUSTED BY 3" MAX HORIZONTALLY TO CLEAR #10 BARS.
- 16. FOR DECK DRAIN OUTLET THROUGH COLUMN REINF CAGE, SEE "DETAIL 1" ON "PIERS 2 & 8 LAYOUT" SHEET.

17. VERTICAL HIGH FLOW PIPE LOCATION MAY BE ADJUSTED TO CLEAR CONTINUOUS HORIZONTAL LOW FLOW PIPE THROUGH COLUMN.



						APPR. /
		7/31/15				DATE
		RECORD DRAWING	ROADWAY,GRADING,	DRAINAGE, STRIPING,	SIGNAL & BRIDGE REVS	NOILLINOSE
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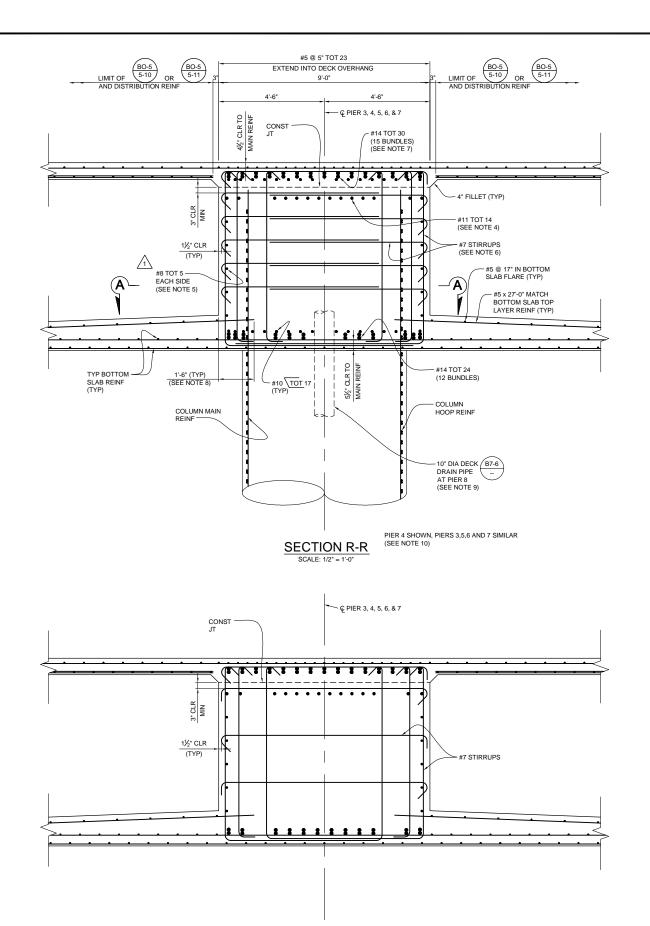


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T. KIRILOV / F. SANCHEZ	DRAWN BY:	J. SALDANA	DRAWING CODE:	FILE NAME:	PLOT DATE: 09/17/15
ORANGE COUNTY	PUBLIC WORKS		PREPARED BY:	METATORINA INTO AND A COMMISSION OF THE PROPERTY OF THE PROPER	CONSULTING \$5 WAR CHARGE CONTRACTOR

JAD BRIDGE +00.00 , **6 & 7** COW CAMP ROAD CHIQUITA CANYON BI TO STATION 76+0 PIERS 3, 4, 5, 6 LAYOUT

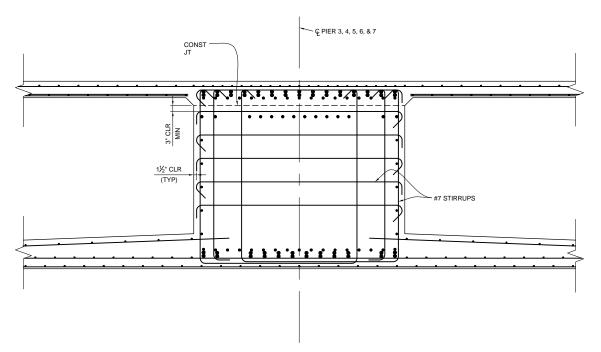
BR-18

Sheet **74** of 115



 $\underline{\mathsf{NOTE}} .$ FOR INFORMATION NOT SHOWN, SEE SECTION R-R

SECTION T-T PIERS 3,5,6, AND 7 SHOWN, PIER 4 SIMILAR (SEE NOTE 10) SCALE: 1/2" = 1'-0"



NOTE: FOR INFORMATION NOT SHOWN, SEE SECTION R-R

– ငူ GIRDER

GIRDER REINF

(SEE NOTE 3)

SECTION A-A PIER 4 SHOWN, PIERS 3,5,6 AND 7 SIMILAR (SEE NOTE 10)

Ç COLUMN

10" DIA DECK B7-6

SEE NOTE 2

DRAIN PIPE

AT PIER 4

SECTION S-S PIERS 3,5,6, AND 7 SHOWN, PIER 4 SIMILAR (SEE NOTE 10)

NOTES:

© PIERS 3, 4, 5, 6, & 7

#14 PIER CAP

(SEE NOTE 1)

BOTTOM MAIN REINF BUNDLED VERTICALLY

- PRIOR TO COLUMN CONCRETE PLACEMENT. THE CONTRACTOR SHALL ARRANGE. ROTATE, AND SPACE COLUMN REINFORCING CAGE TO ENSURE PLACEMENT OF PIER CAP BOTTOM MAIN REINF AS SHOWN.
- 2. MAXIMUM 4 LONGITUDINAL COLUMN MAIN REINF BARS MAY BE CUT BY 1'-3" TO CLEAR P/S DUCTS.
- 3. LONGITUDINAL GIRDER REINF MAY BE ADJUSTED TO CLEAR COLUMN MAIN REINF.
- 4. REINF MAY BE BENT OR LOWERED TO CLEAR P/S DUCTS.
- SIDE FACE REINF SHALL BE SPACED EQUALLY AT 12" MAX AND MAY BE DISCONTINUOUS AT UTILITY OPENINGS.
- 6. FOR PIER CAP STIRRUP CONFIGURATION, SEE "TYPICAL PIER DETAILS NO. 1" SHEET.
- EXTEND PIER CAP TOP BUNDLE MAIN REINF INTO DECK OVERHANG SLAB. TERMINATE BOTTOM BUNDLE REINF AT INSIDE EDGE OF DECK OVERHANG.
- TERMINATE TYPICAL SOFFIT TOP LAYER TRANSVERSE REINF AT FACE OF PIER CAP. DISTRIBUTE TYPICAL SOFFIT BOTTOM LAYER TRANSVERSE REINF INTO THE PIER CAP.
- TYPICAL SOFFIT BOTTOM LAYER TRANSVERSE REINF MAY BE TERMINATED TO CLEAR DRAINAGE PIPE.
- 10. BOTTOM PIER CAP REINF IN PIER 4 WITH DRAINAGE PIPE SHALL BE DISTRIBUTED AS SHOWN IN SECTIONS R-R AND A-A. BOTTOM PIER CAP REINF IN PIERS 3,5,6, AND 7 SHALL BE DISTRIBUTED AS SHOWN IN SECTIONS S-S AND T-T.

THIS RECORD DRAWING HAS BEEN PEPRABED, IN PART, BASED UPON INFORMATION FURNISHED BY OTHERS. WHILE THIS INFORMATION IS BELIEVED TO BE RELIABLE. THE ENGINEER CANNOT ASSURE ITS ACCURACY AND THUS IS NOT RESPONSIBLE FOR THE ACCURACY OF THIS RECORD DRAWING OR FOR ANY ERRORS OR OMISSIONS WHICH MAY HAVE BEEN INCORPORATED INTO IT AS A RESULT. THOSE RELINGO ON THIS RECORD DRAWING ARE ADVISED TO OBTAIN INDEPENDENT VERIFICATION OF ITS ACCURACY BEFORE APPLYING IT FOR ANY PIRPORS.

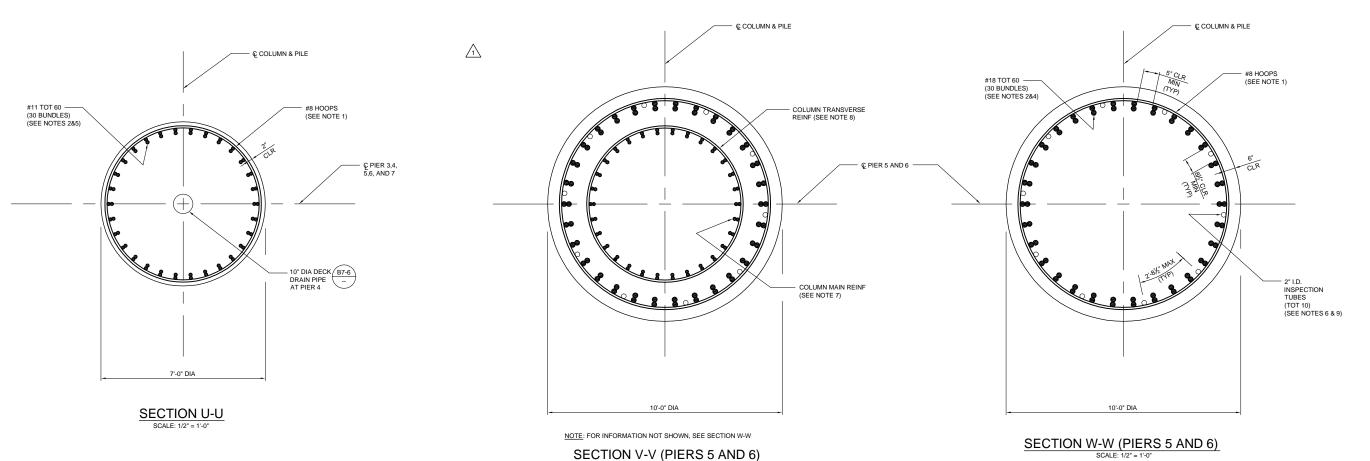
DATE JULY 2015




BR-19

COW CAMP ROAD CHIQUITA CANYON BRIDGE TO STATION 76-00.00 PIERS 3,4,5,6 & 7 DETAILS NO. 1 RECORD DRAWING

Sheet **75** of 115



SCALE: 1/2" = 1'-0"

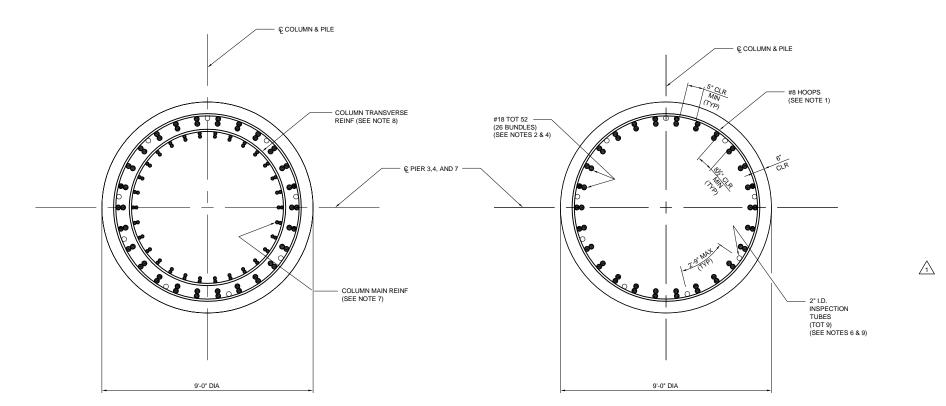


NOTES:

- ALL HOOPS SHALL BE BUTT WELDED AND SHALL MEET THE "ULTIMATE SPLICE" REQUIREMENTS.
- COLUMN AND PILE MAIN REINF, WHERE PERMITTED, SHALL MEET THE "ULTIMATE SPLICE" REQUIREMENTS.
- 3. LAPPED SPLICES ARE NOT PERMITTED IN COLUMN AND PILE REINFORCEMENT
- 4. NO SPLICES PERMITTED IN PILE MAIN REINF WITHIN 50'-0" OF PILE CUT-OFF ELEVATION.
- 5. ADJUST SPACING OF COLUMN MAIN REINF TO CLEAR DRAIN OUTLET.
- 6. ALLOW FOR 3" MIN CLEAR SPACING TO INSPECTION TUBES.
- ALTERNATE EMBEDMENT LENGTH OF COLUMN MAIN REINF INTO PILE SHAFT AT 20'-0' AND 25'-0' AT PIERS 3, 4, 5, AND 7. ALTERNATE EMBEDMENT LENGTH AT 63'-0" AND 68'-0" AT PIER 6.
- COLUMN TRANSV REINF SHALL EXTEND OVER THE ENTIRE EMBEDDED LENGTH OF THE COLUMN CAGE.
- INSPECTION PIPES SHALL BE 40 PVC, AND SHALL CONFORM WITH THE PROVISIONS IN SECTION 49-3 OF CALTRANS STANDARD SPECIFICATIONS.

RECORD DRAWING

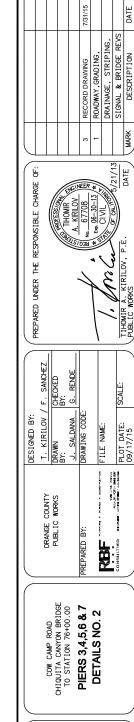THIS RECORD DEAWING HAS BEEN PEPRABED. IN PART, BASED UPON INFORMATION FURNISHED BY OTHERS. WHILE THIS INFORMATION IS SELIEVED TO BE RELIABLE, THE ENDINEER CANNOT ASSURE ITS ACCURACY, AND THUS IS NOT RESPONSIBLE FOR THE ACCURACY OF THIS RECORD DEAWING OF FOR ANY ERRORS OR OMISSIONS WHICH MAY HAVE BEEN INCORPORATED INTO IT AS A RESULT.

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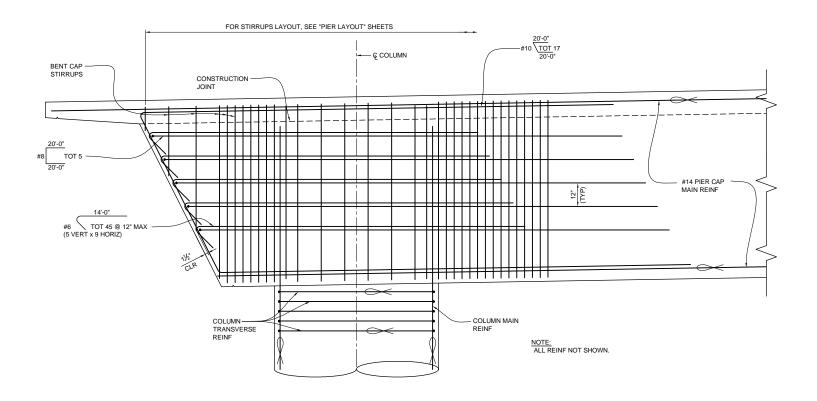
BR-20

Sheet **76** of 115


SECTION V-V (PIERS 3,4, AND 7)

NOTE: FOR INFORMATION NOT SHOWN, SEE SECTION W-W

SECTION W-W (PIERS 3,4, AND 7)



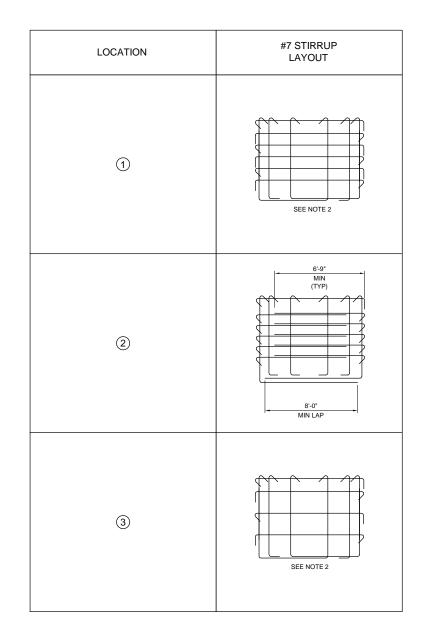DETAIL "A" SCALE: 1/2" = 1'-0"



PIER CAP STIRRUP CONFIGURATION NO SCALE

NOTES:

- 1. FOR STIRRUPS LAYOUT, SEE "PIER LAYOUT" SHEETS.
- 2. VERTICALLY AND HORIZONTALLY ALTERNATE 135° BENDS ON STIRRUP CROSS-TIES.

LEGEND:

BUNDLED BARS



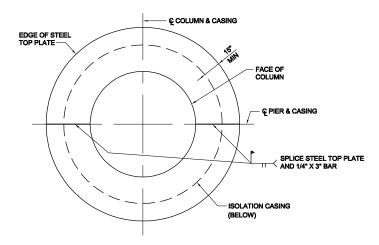
Sheet Reference Number

BR-21


Sheet 77 of 115

RECORD DRAWING


THIS RECORD DRAWING HAS BEEN PREPARED. IN PART, BASED UPON INFORMATION FURNISHED BY OTHERS. WHILE THIS INFORMATION IS BELIEVED TO BE RELIABLE, THE ENDINEER CANNOT ASSURE ITS ACCURACY, AND THUS IS NOT RESPONSIBLE FOR THE ACCURACY OF THIS RECORD DRAWING OF FOR ANY ERRORS OR OMISSIONS WHICH MAY HAVE BEEN INCORPORATED INTO IT AS A RESULT. AND PROPERTY OF THE PROPERTY OF THE ACCURACY DRAWING ARE ADVISED TO STAIN INDEPENDENT VERIFICATION OF ITS ACCURACY BEFORE APPLYING IT FOR ANY PURPOSE.



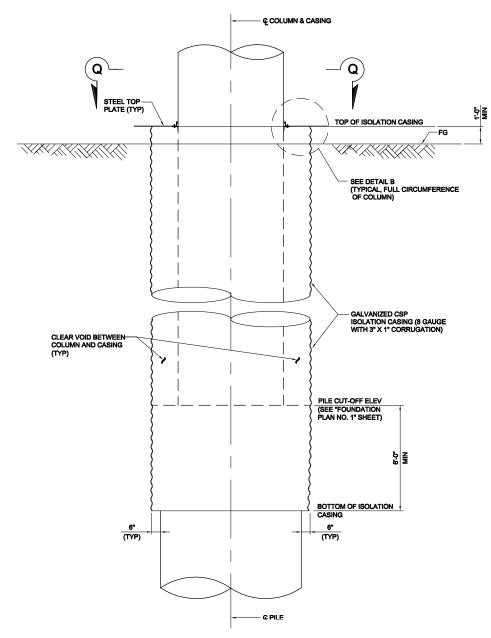$\frac{\text{SECTION Q-Q}}{\text{NO SCALE}}$



COLUMN ISOLATION CASING NO SCALE

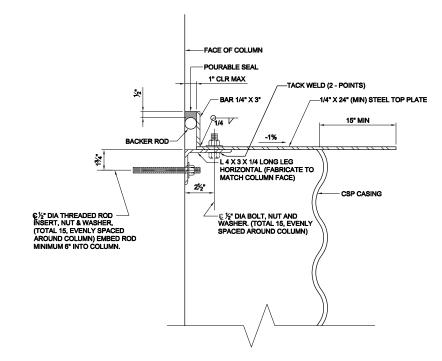

DETAIL B

NOTES:

1. ISOLATION CASINGS SHALL BE INSTALLED AT PIERS 2, 3, 5, 7, AND 8.
 NO ISOLATION CASINGS ARE REQUIRED AT PIERS 4 AND 6.

2. ALL STEEL PARTS SHALL BE GALVANIZED AFTER FABRICATION.

3. FOR PILE SIZES AND PILE CUT-OFF ELEVATIONS, SEE "FOUNDATION PLAN NO. 1" SHEET.

RECORD DRAWING

THIS RECORD DRAWING HAS BEEN PREPARED, IN PART, BASED UPON INFORMATION FURNISHED BY OTHERS, WHILE THIS INFORMATION IS BELIEVED TO BE RELIABLE. THE ENDINEER CANNOT ASSURE ITS ACCURACY, AND THUS IS NOT RESPONSIBLE FOR THE ACCURACY WHICH MAY THE PROPERTY OF THE ACCURACY WHICH MAY THE BEEN INCORPORATED INTO IT AS A BESULT. THOSE RELIVING ON THIS RECORD DRAWING ARE ADVISED TO OBTAIN INDEPENDENT VERIFICATION OF ITS ACCURACY BEFORE APPLYING IT FOR ANY PURPOSE.

RBF CONSULTING



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						GGGV
		7/31/15				Ļ
		RECORD DRAWING	ROADWAY,GRADING,	DRAINAGE, STRIPING,	SIGNAL & BRIDGE REVS	LACT TOTOGOTO
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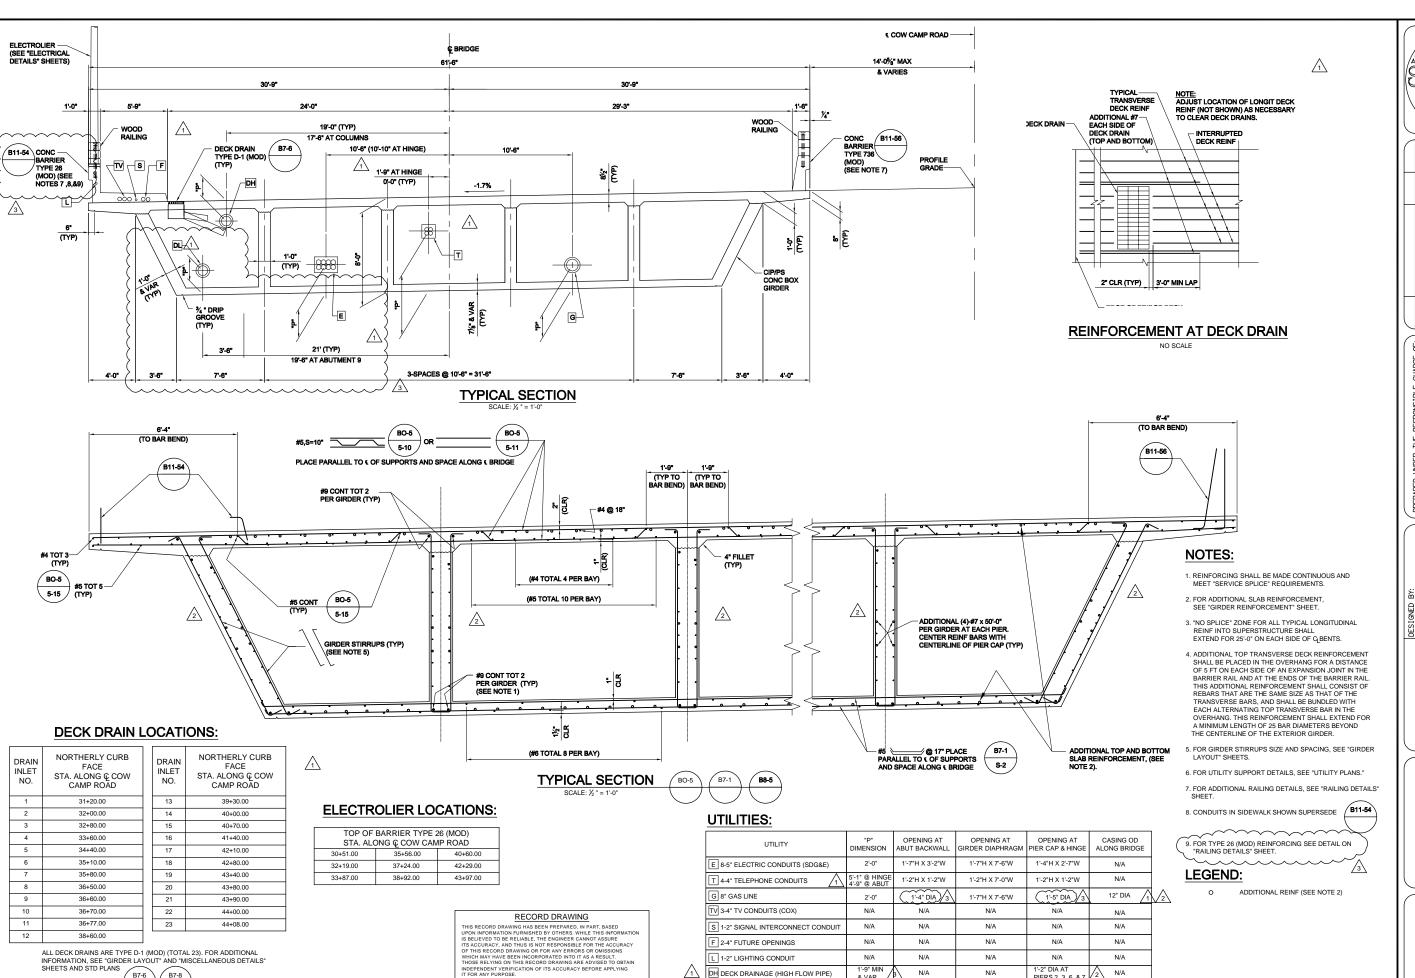


F. SANCHEZ	CHECKED BY:	G. RENDE			SCALE:
T. KIRILOV / F. SANCHEZ	DRAWN BY:	J. SALDANA	DRAWING CODE:	FILE NAME:	PLOT DATE: 09/17/15
ORANGE COUNTY	PUBLIC WORKS		PREPARED BY:	MOUNTAINMENT HOUSE COMMENTS	CONSULTING \$5 WARD SECTION OF THE SE

COW CAMP ROAD CHIQUITA CANYON BRIDGE TO STATION 76+00.00 TYPICAL PIER DETAILS NO. 2

BR-22

Sheet **78** of 115



N/A

N/A

2'-6"

F 2-4" FUTURE OPENINGS

L 1-2" LIGHTING CONDUIT

DATE JULY 2015

DH DECK DRAINAGE (HIGH FLOW PIPE)

DL DECK DRAINAGE (LOW FLOW PIPE)

ALL DECK DRAINS ARE TYPE D-1 (MOD) (TOTAL 23) FOR ADDITIONAL

INFORMATION, SEE "GIRDER LAYOUT" AND "MISCELLANEOUS DETAILS"
SHEETS AND STD PLANS

B7-8

N/A

N/A

N/A

1'-8" DIA

N/A

N/A

PIERS 2, 3, 6, & 7

1'-2" DIA

N/A

N/A

1'-7"H X 1'-10"W

N/A

N/A

N/A

N/A




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PUBLIC WORKS	DRAWN BY:	CHECKED BY:
	J. SALDANA	G. RENDE
PREPARED BY:	DRAWING CODE:	
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CONSULTING PRIMARY OF SERVICE AND SECONDARY	PLOT DATE:	SCALE:

COW CAMP ROAD CHIQUITA CANYON BRIDGE TO STATION 76+00.00 TYPICAL SECTION

BR-23

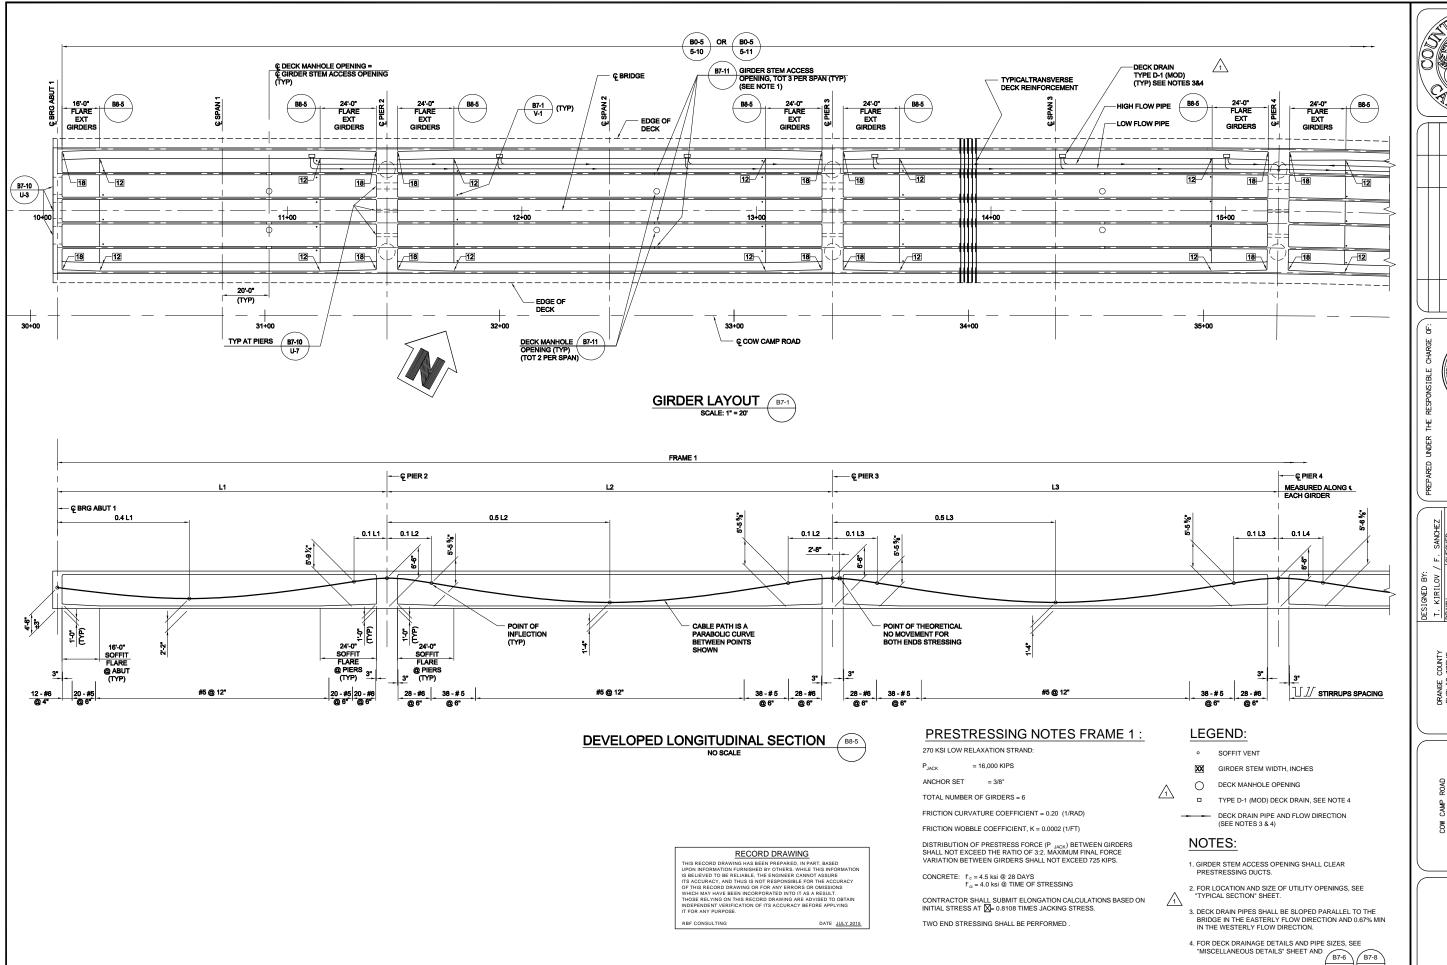Sheet **79** of 115








ORANGE COLINTY	T. KIRILOV / F. SANCH	F. SANCH
PUBLIC WORKS	DRAWN BY:	CHECKED BY:
	J. SALDANA	G. RENDE
PREPARED BY:	DRAWING CODE:	
HELICIALDHEEN & HOWERS & DANIELS	FILE NAME:	
MOTOR WILD BOWN - SERVICE BUILD BOOD	TT NATE	COAL E.

COW CAMP ROAD
CHIQUITA CANYON BRIDGE
TO STATION 76-00.00
GIRDER LAYOUT NO. 1

BR-24

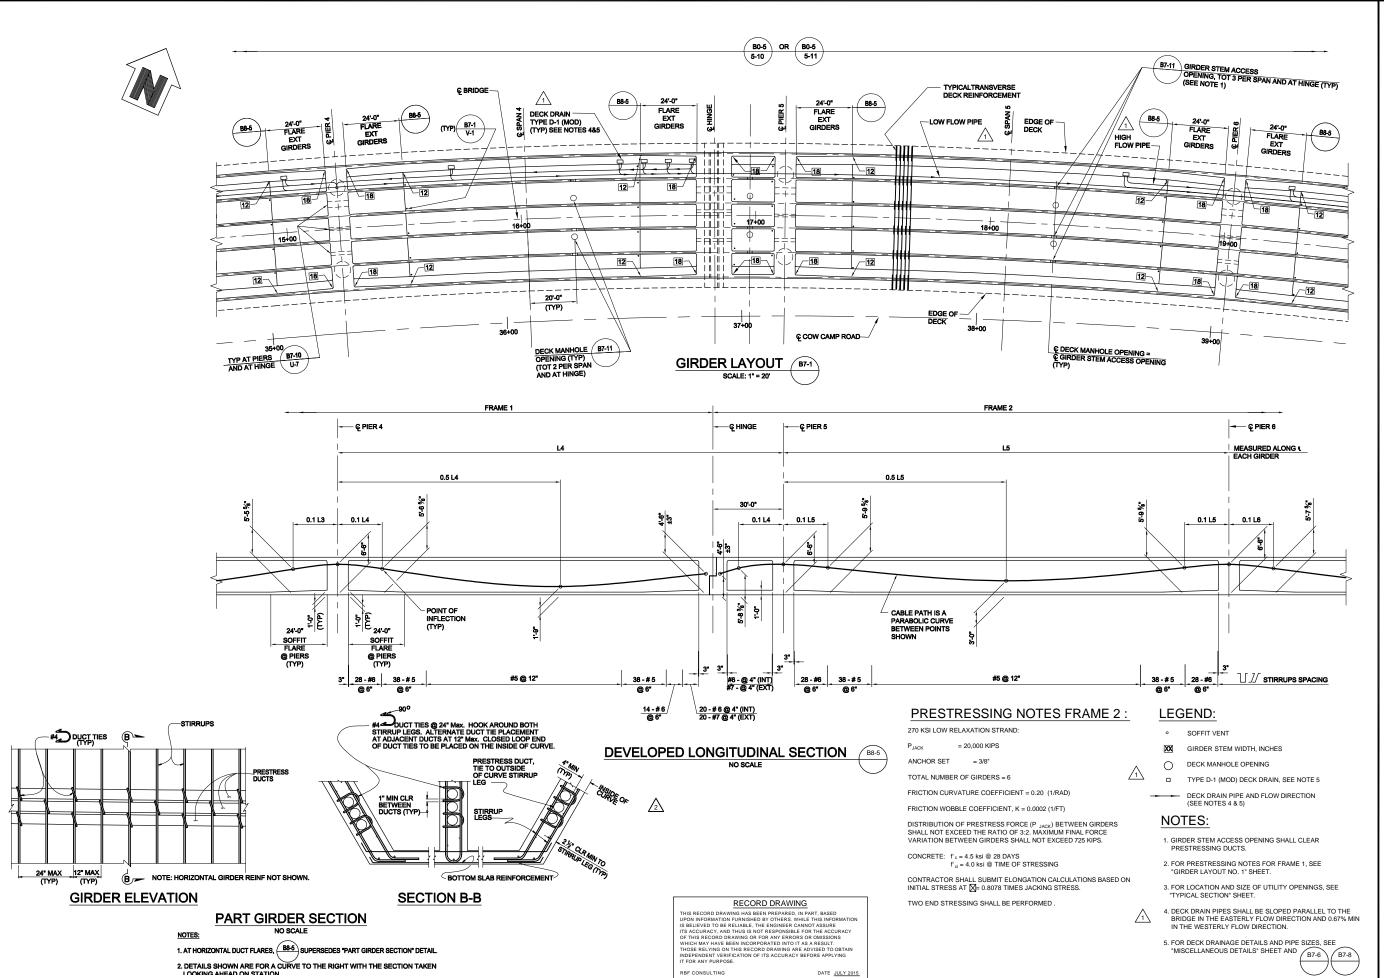Sheet 80 of 115



RECORD DRAWING
 REVISIONS AFTER
 BID SET DATED 05-01-2013
 ROADIMAY, GRADING,
 DRAINAGE, STRIPING,
 SIGNAL & BRIDGE REVS

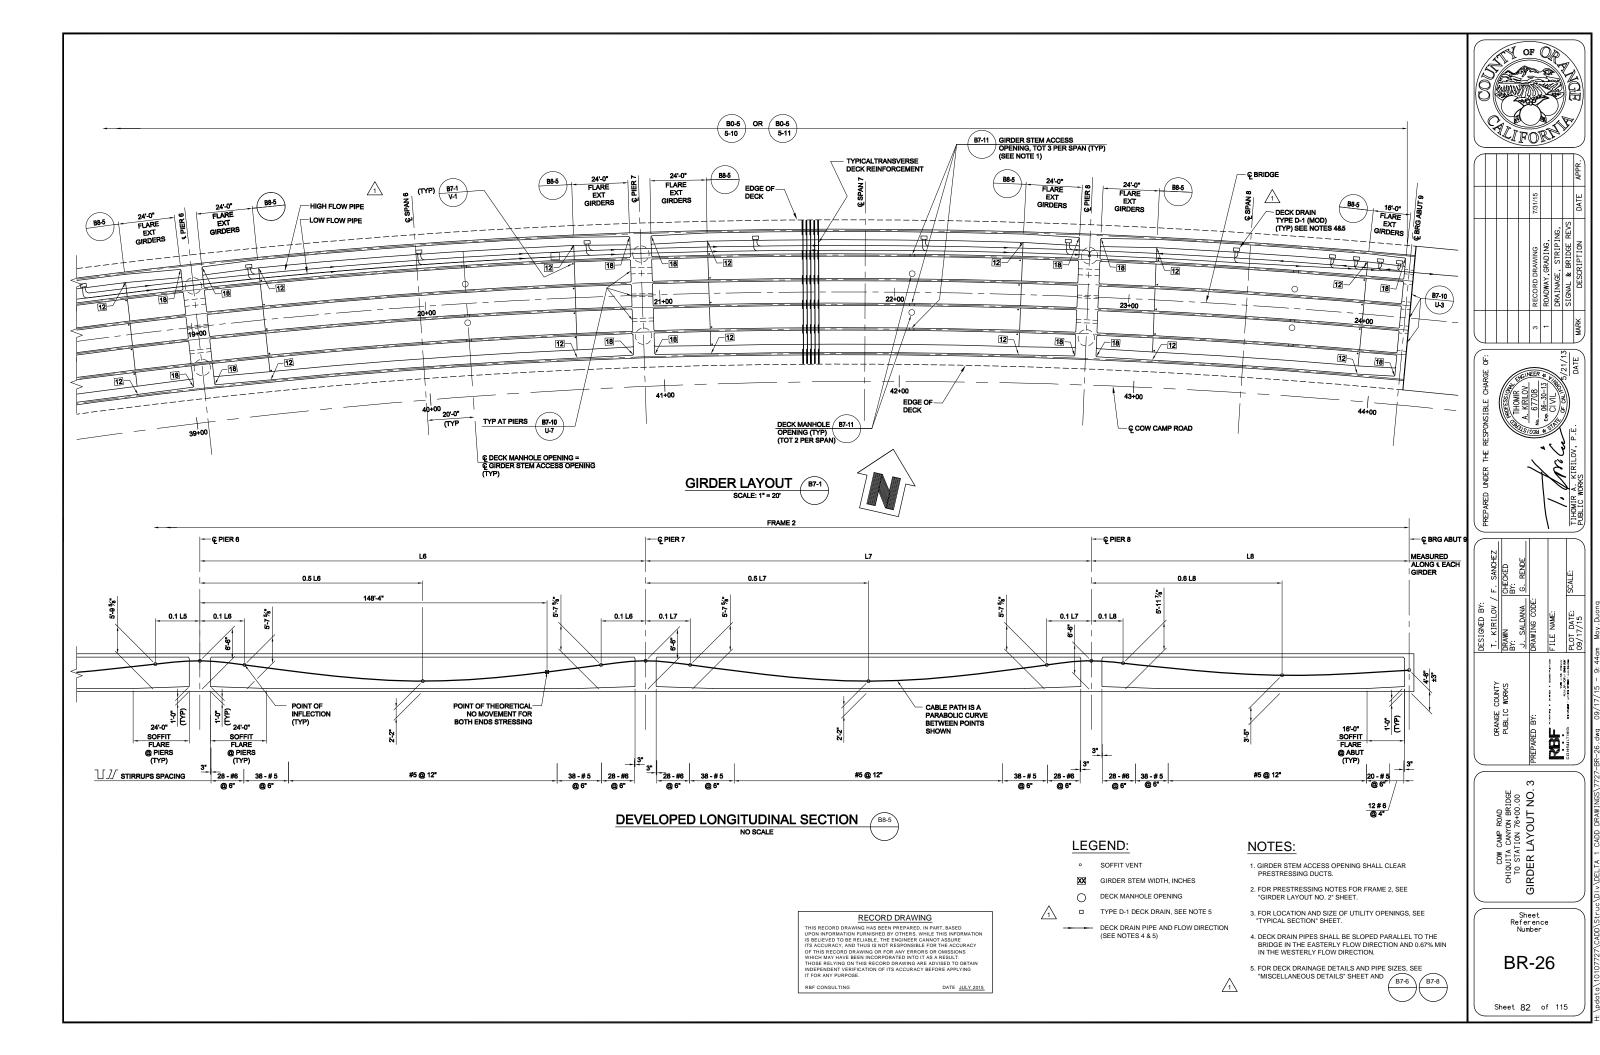
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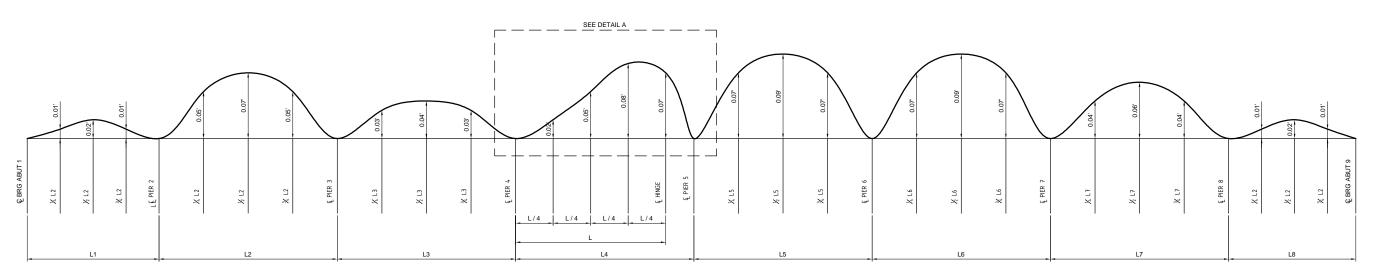
COW CAMP ROAD
CHIQUITA CANYON BRIDGE
TO STATION 76+00.00
GIRDER LAYOUT NO. 2


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BR-25

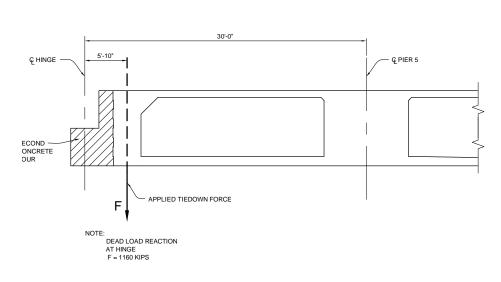Sheet **81** of 115








NOTES:

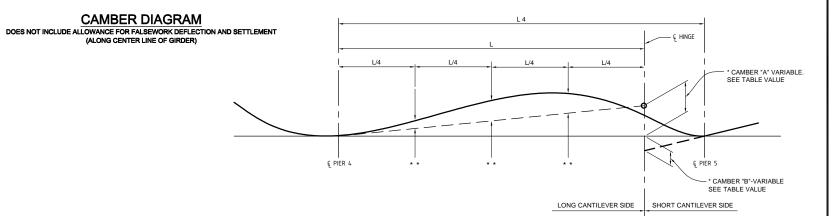- 1. CONTRACTOR TO PROVIDE TIE-DOWN SYSTEM TO PREVENT HINGE SEAT CURL.
 MINIMUM CAPACITY OF TIE-DOWNS SHALL BE 1.2 x DEAD LOAD REACTION (F).
- 2. MINIMUM TIE-DOWN STRESS DUE TO 1.2 x DEAD LOAD REACTION (F), SHALL NOT EXCEED 0.75 Fu OF PRESTRESSING STEEL.
- 3. CONTRACTOR SHALL APPLY ONLY DEAD LOAD REACTION (F) TO THE TIE-DOWN SYSTEM. ADDITIONAL ADJUSTMENTS TO THE TIE-DOWN SYSTEM MAY BE REQUIRED PERIODICALLY TO MANTAIN GRADE AND PROFILE.
- 4. NO TENSION IS ALLOWED ON TIE-DOWNS UNTIL SUPERSTRUCTURE HAS BEEN STRESSED.



DETAIL A

- * SEE TABLE FOR VALUES TO USE DEPENDS ON PERIOD OF TIME BETWEEN PRESTRESSING OF SHORT CANTILEVER SIDE AND LOAD TRANSFER FROM LONG CANTILEVER SIDE.
- **ADJUSTED CAMBER VALUES ARE AT QUARTER POINTS OF LENGTH BETWEEN C PIER AND

TIME DEPENDENT CAMBER VALUES (FEET)

								<u> </u>		
	LOCATION	CAMBER	ELAPSED TIM	E IN DAYS MEA	SURED FROM F	RESTRESSING	SHORT HINGE	SIDE TILL CLOS	URE AND LOAD	TRANSFER
		VALUE	30	60	90	120	180	240	360	720
	SPAN 4 HINGE	"A"	0.041	0.031	0.021	0.016	0.015	0.014	0.011	0.008
	HINGE	"B"	0.073	0.072	0.072	0.072	0.071	0.071	0.071	0.071

RECORD DRAWING

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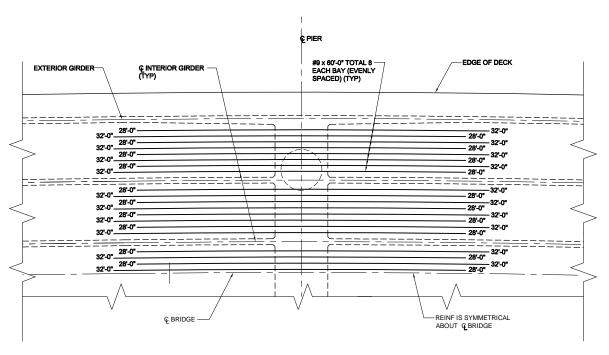


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COW CAMP ROAD
CHIQUITA CANYON BRIDGE
TO STATION 76+00.00
CAMBER DIAGRAM

BR-27

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ADDITIONAL TOP SLAB REINFORCEMENT @ PIERS (2,3,4,6,7,8,) SCALE: 1/8 " = 1'-0"

- REINF IS SYMMETRICAL င့ BRIDGE — ABOUT GBRIDGE - 28'-0" - 28'-0" 32'-0" 28'-0" -32'-0" 28'-0" -32'-0" -28'-0" 32'-0" - 28'-0" 32'-0" - 28'-0" 32'-0" - 28'-0" 32'-0" 32'-0" <u>28'-0" -</u> 32'-0" <u>28'-0" -</u> 32'-0" 32'-0" 28'-0" 28'-0" 32'-0" - 28'-0" 32'-0" - 28'-0" 32'-0" 32'-0" <u>28'-0"</u> -#9 x 60'-0" TOTAL 9 -INT BAY (EVENLY SPACED) (TYP) EDGE OF SOFFIT © INTERIOR GIRDER___ (TYP) #9 x 60'-0" TOTAL 6 EXT BAY (EVENLY © EXTERIOR GIRDER -EDGE OF DECK SPACED) (TYP) & PIER

ADDITIONAL BOTTOM SLAB REINFORCEMENT @ PIERS (2,3,4,6,7,8,) SCALE: 1/8 " = 1'-0"


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#9 x 60'-0" TOTAL 4 — EACH BAY (EVENLY © PIER 5 #9 x 78'-0" TOTAL 4 — EACH BAY (EVENLY SPACED) (TYP) (SEE NOTE 2) -EDGE OF DECK Ç EXTERIOR− GIRDER 2" CLR -REINF IS SYMMETRICAL € BRIDGE -ABOUT € BRIDGE

ADDITIONAL TOP SLAB REINFORCEMENT @ PIER 5 (HINGE)

SCALE: 1/8 " = 1'-0"



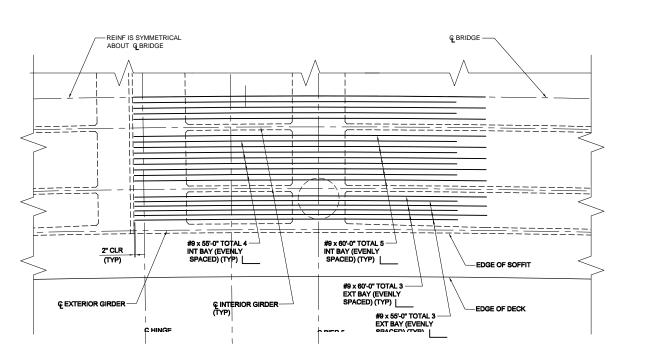ADDITIONAL BOTTOM SLAB REINFORCEMENT @ PIER 5 (HINGE)

SCALE: 1/8 " = 1'-0"

NOTES:

- 1. NO LAP SPLICES ALLOWED IN TOP AND BOTTOM LONGITUDINAL SLAB REINFORCEMENT OVER PIERS.(UNLESS NOTED OTHERWISE)
- 2. MECHANICAL SPLICES OF ADJACENT BARS MUST BE STAGGERED
- 3. NUMBERS AT END OF BARS INDICATE BAR LENGTH FROM C PIER.
- 4. REINF MAY BE ADJUSTED TO CLEAR COLUMN MAIN REINF.


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COW CAMP ROAD
CHIQUITA CANYON BRIDGE
TO STATION 76+00.00
GIRDER
REINFORCEMENT

BR-28

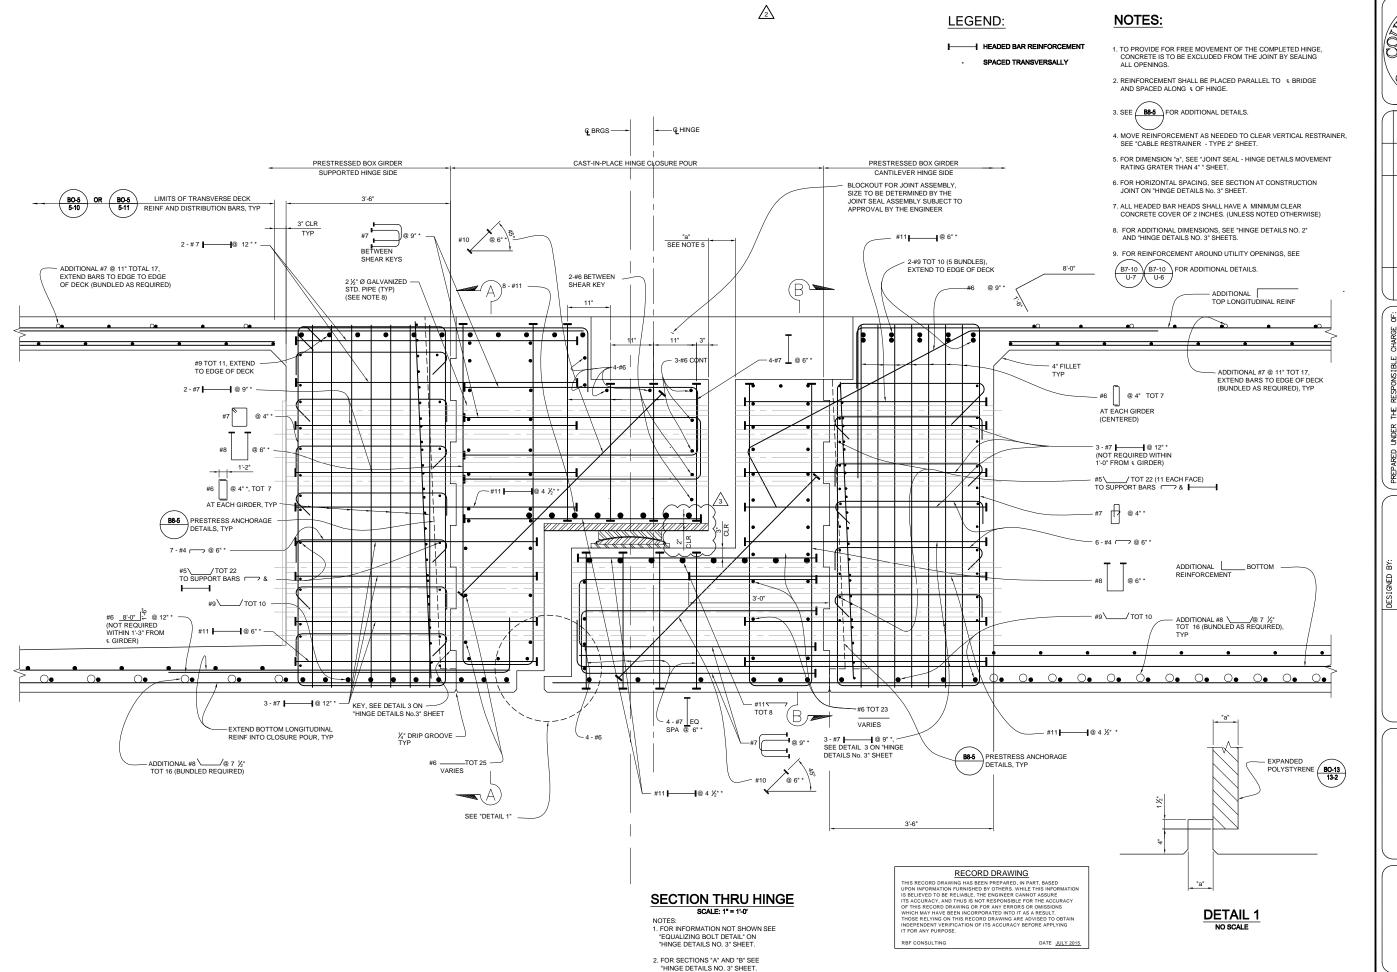Sheet **84** of 115



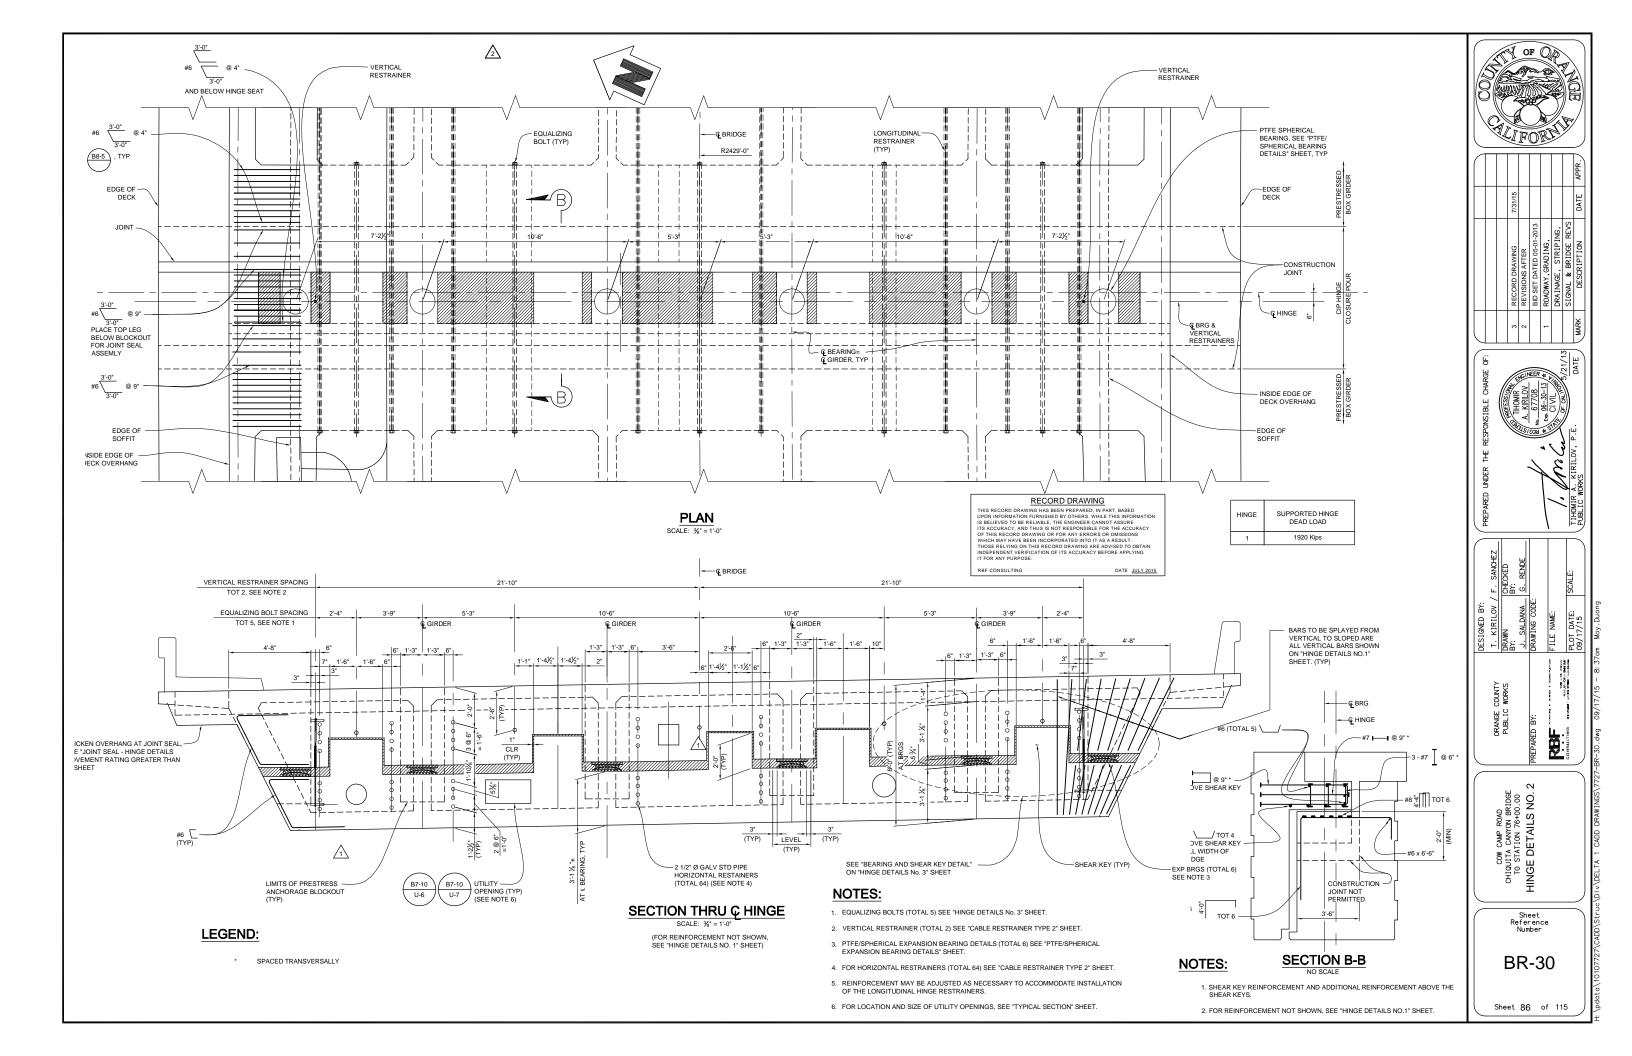
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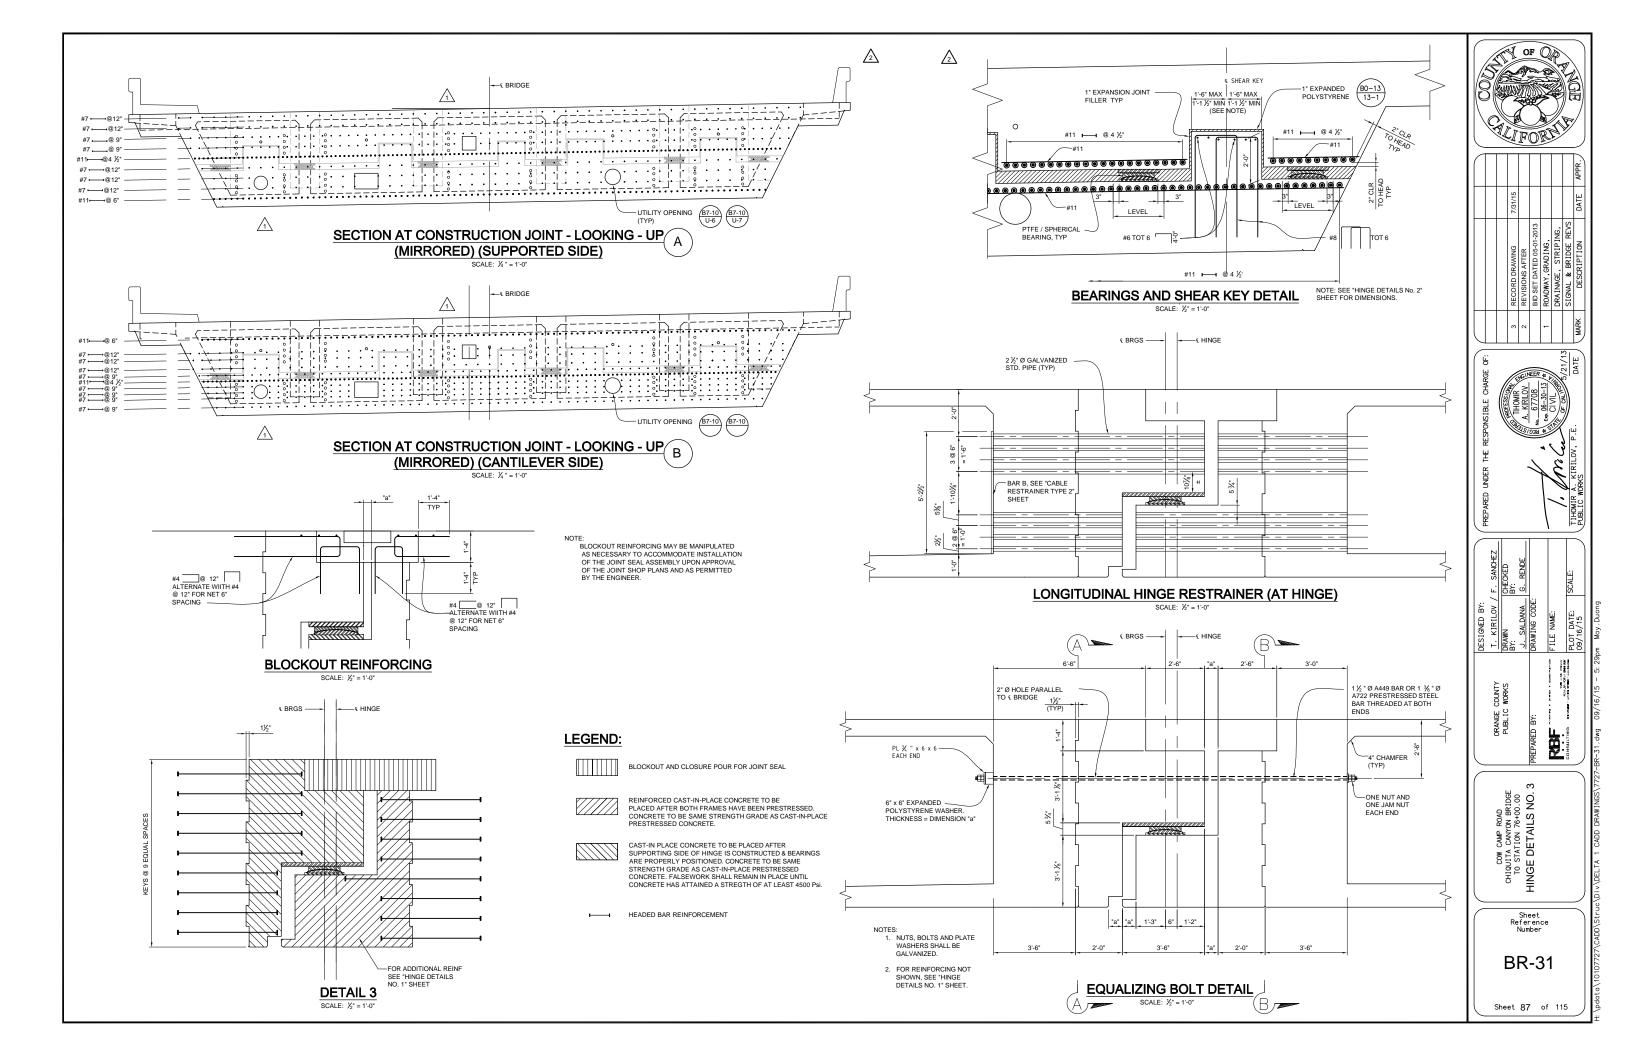
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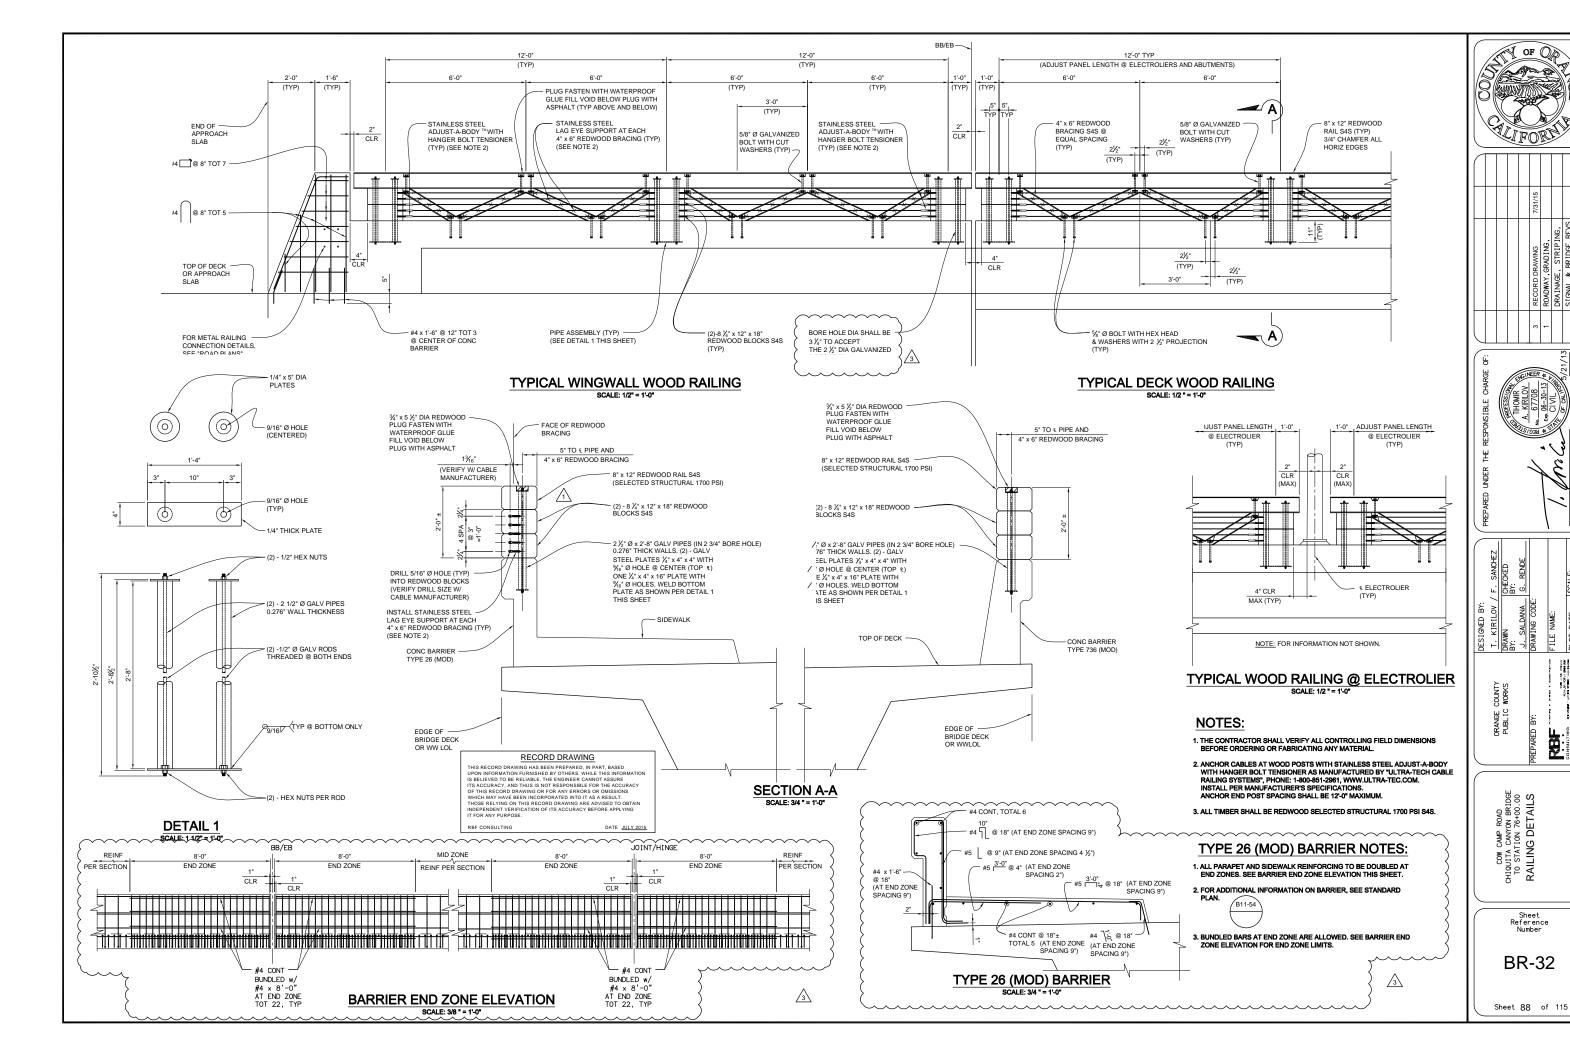
COW CAMP ROAD
CHIQUITA CANYON BRIDGE
TO STATION 76+00.00
HINGE DETAILS NO. 1

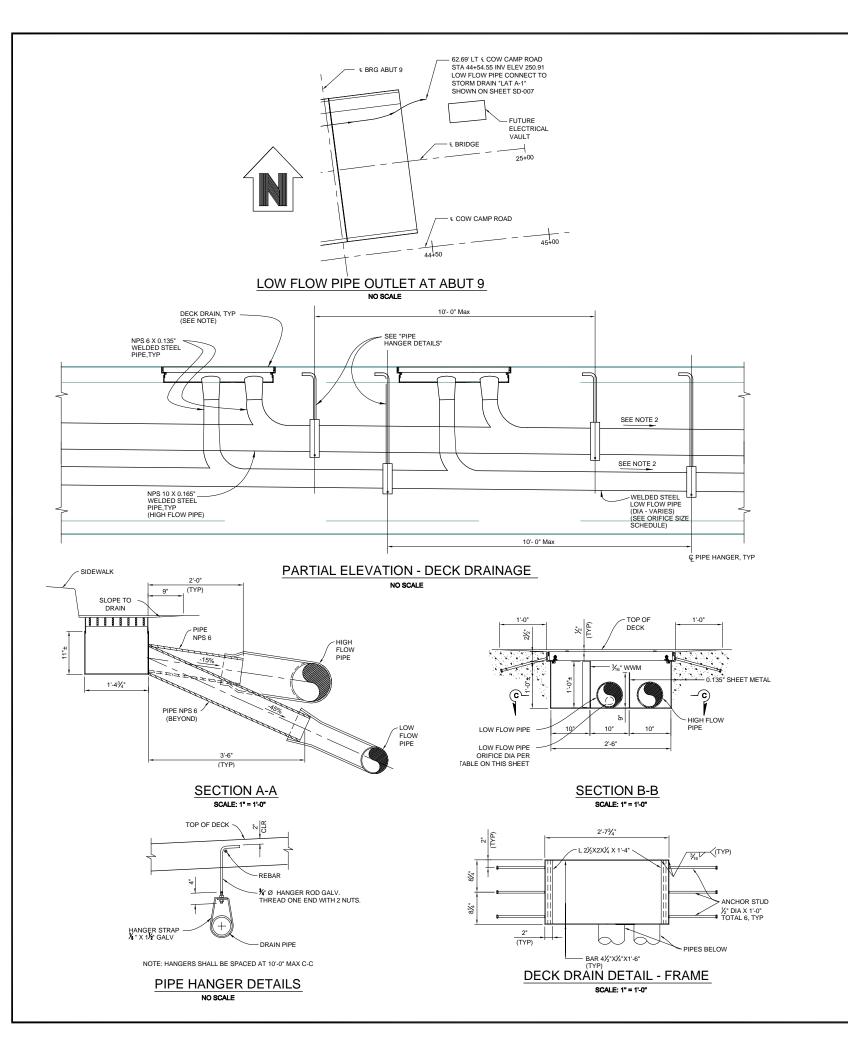
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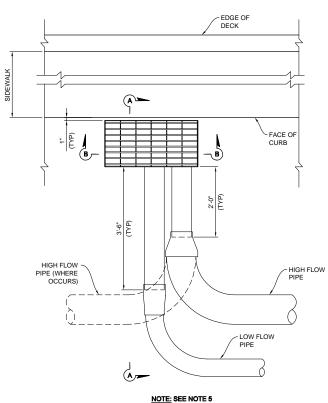
Sheet **85** of 115













PARTIAL PLAN - DECK DRAINAGE

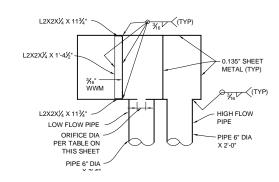RECORD DRAWING THIS RECORD DRAWING HAS BEEN PREPARED. IN PART, BASED UPON INFORMATION FURNISHED BY OTHERS. WHILE THIS INFORMATION IS BELIEVED TO BE RELIABLE, THE ENGINEER CANNOT ASSURE ITS ACCURACY, AND THUS IS NOT RESPONSIBLE FOR THE ACCURACY OF THIS RECORD DRAWING ON FOR ANY ERRORS OR OMISSIONS THOSE RELIYED ON THIS RECORD DRAWING ARE ADVISED TO OBTAIN INDEPENDENT VERHICATION OF ITS ACCURACY BEFORE APPLYING IT FOR ANY PURPOSE. RBF CONSULTING DATE JULY 2015



SECTION C-C SCALE: 1" = 1'-0"

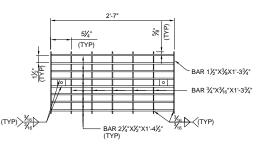

DECK DRAIN DETAIL - GRATE

SCALE: 1" = 1'-0"

ORIFI	CE SIZE SCHE	DULE
INLET NO.	ORIFICE SIZE	LOW FLOW PIPE SIZE DIAMETER
1	41/4"	
2	23/4"	6"
3	23/4"	6
4	23/4"	
5	23/4"	
6	25%"	
7	25%"	
8	25%"	8"
9	1"	8
10	1"	
11	1"	
12	41/4"	
13	25%"	
14	25%"	
15	25%"	
16	25/8"	
17	25%"	
18	25%"	10"
19	2½"	
20	2"	
21	1"	
22	1"	
23	1"	

NOTES:

- 1. FOR LOCATION AND SIZE OF UTILITY OPENINGS, SEE "TYPICAL SECTION" SHEET.
- 2. DECK DRAIN PIPES SHALL BE SLOPED PARALLEL TO THE BRIDGE IN THE EASTERLY FLOW DIRECTION AND 0.67% MIN IN THE WESTERLY FLOW DIRECTION.
- 4. FOR ADDITIONAL DRAINAGE DETAILS AND NOTES, SEE



5. ORIENTATION OF DECK DRAIN INLETS INSTALLATION SHALL BE EXACTLY AS SHOWN IN "PARTIAL PLAN - DECK DRAINAGE" DETAIL ON THIS SHEET. LOW FLOW PIPE SHALL BE THE FIRST TO COLLECT THE INCOMING LOW FLOW OF STORM WATER.

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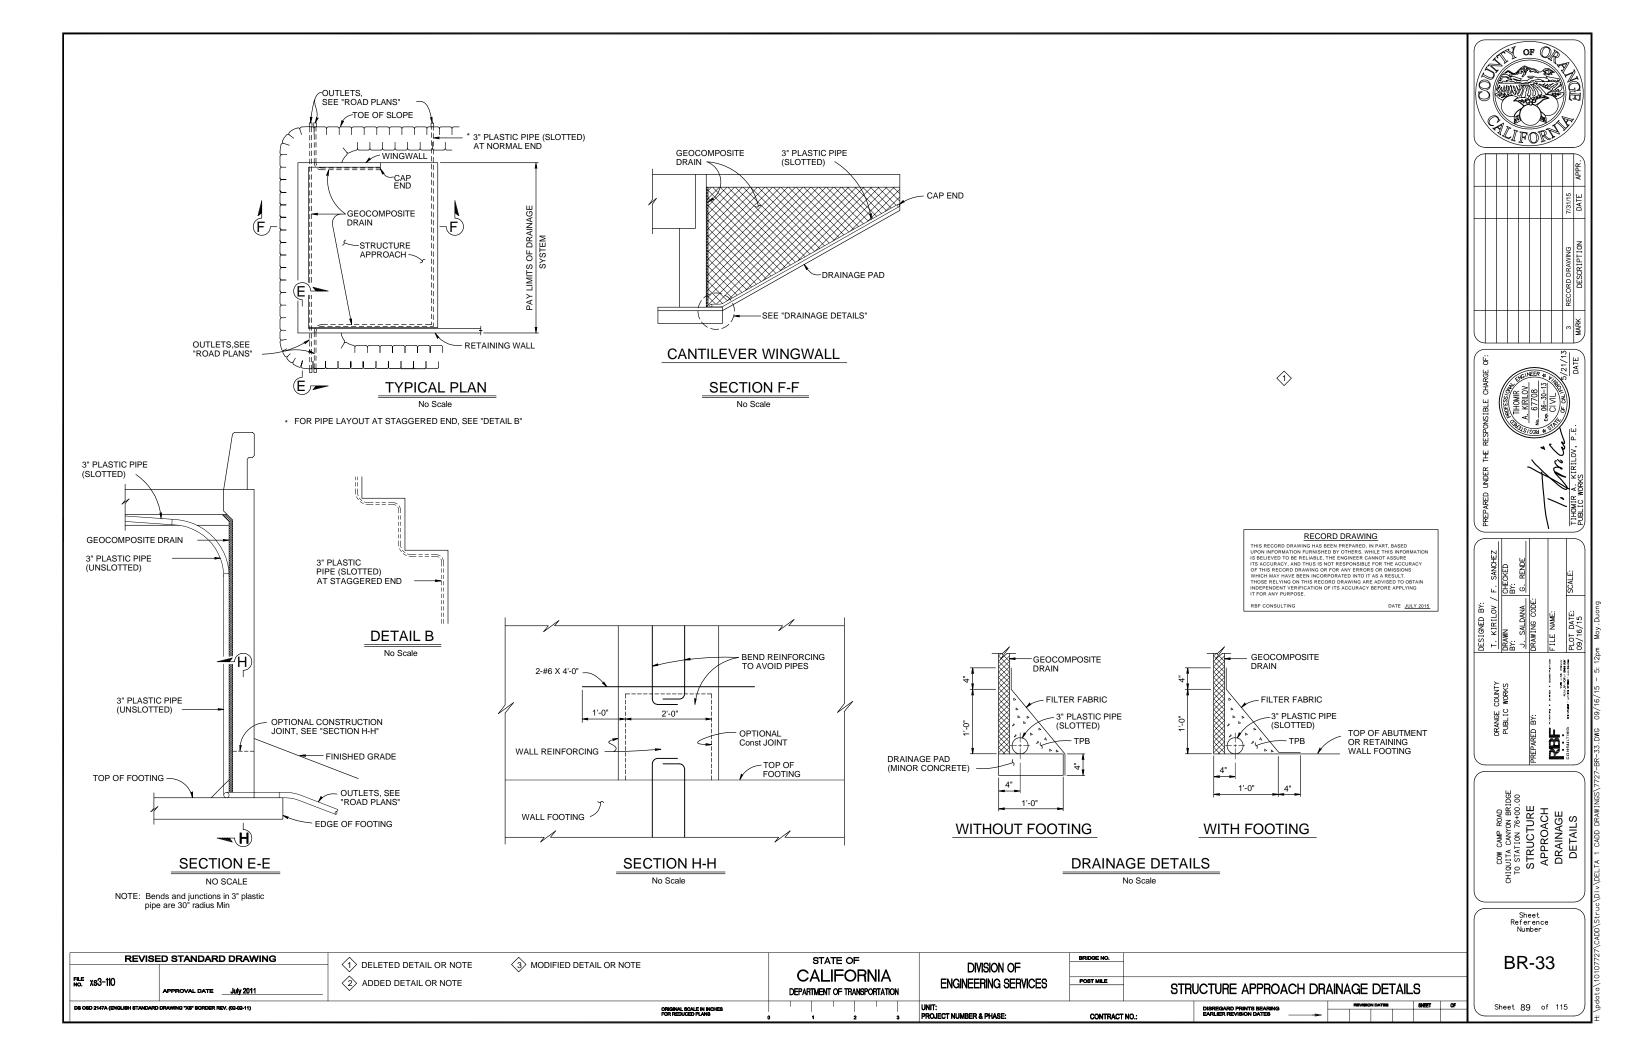
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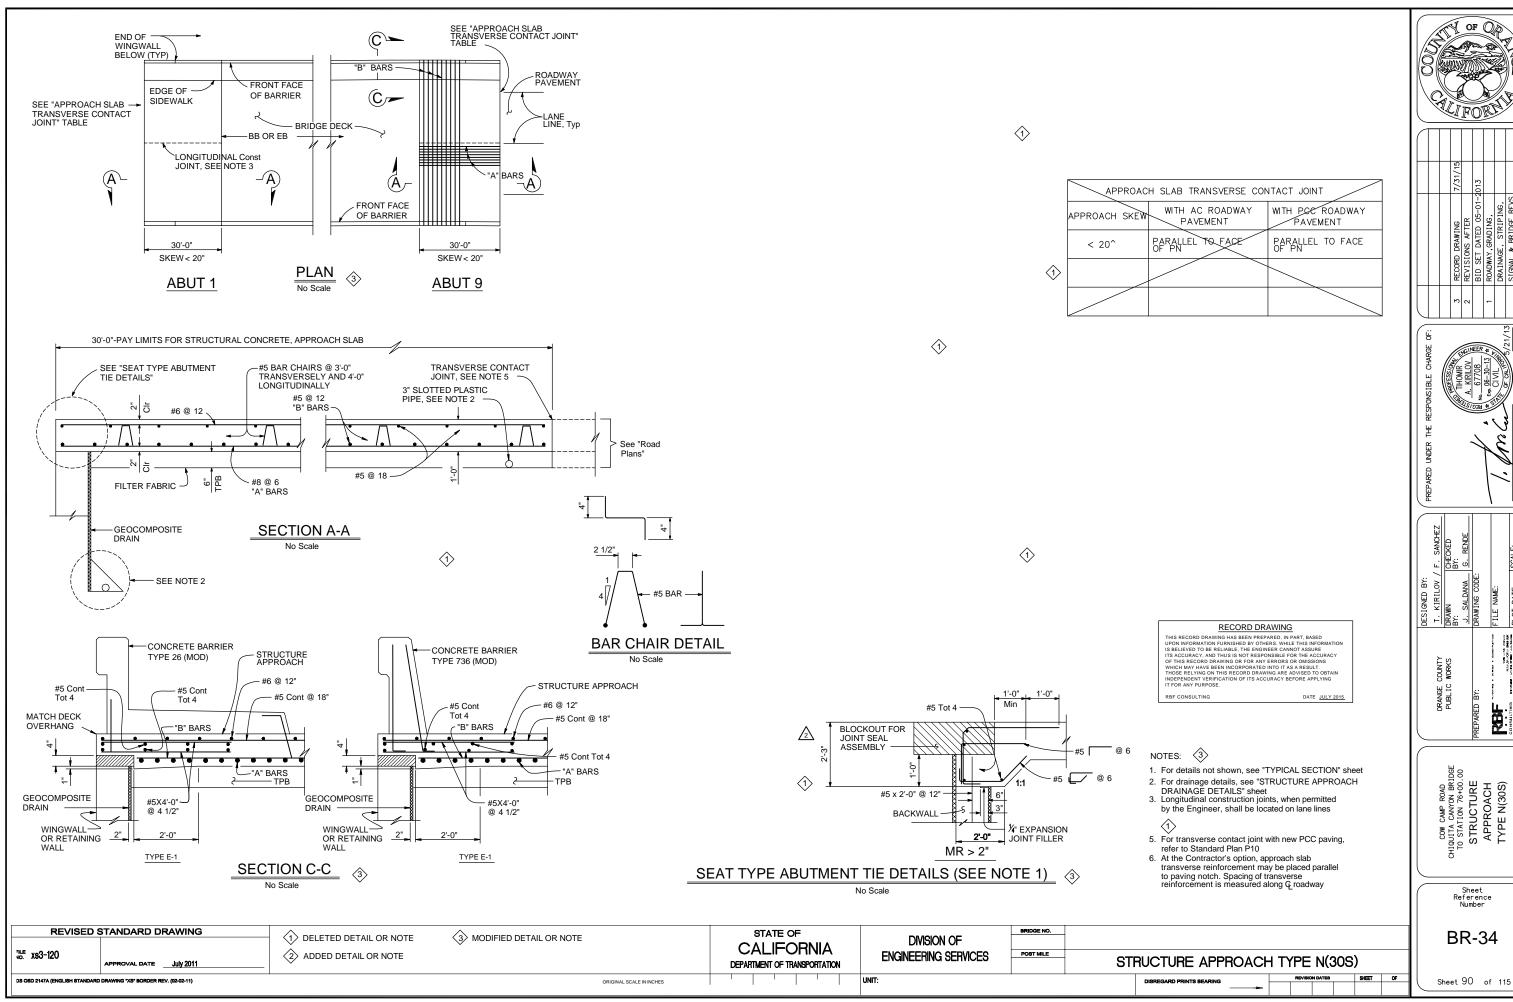
COW CAMP ROAD
CHIQUITA CANYON BRIDGE
TO STATION 76+00.00
MISCELLANEOUS
DETAILS

Sheet Reference Number

BR-32A

Sheet 88A of 115








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Sheet 90 of 115





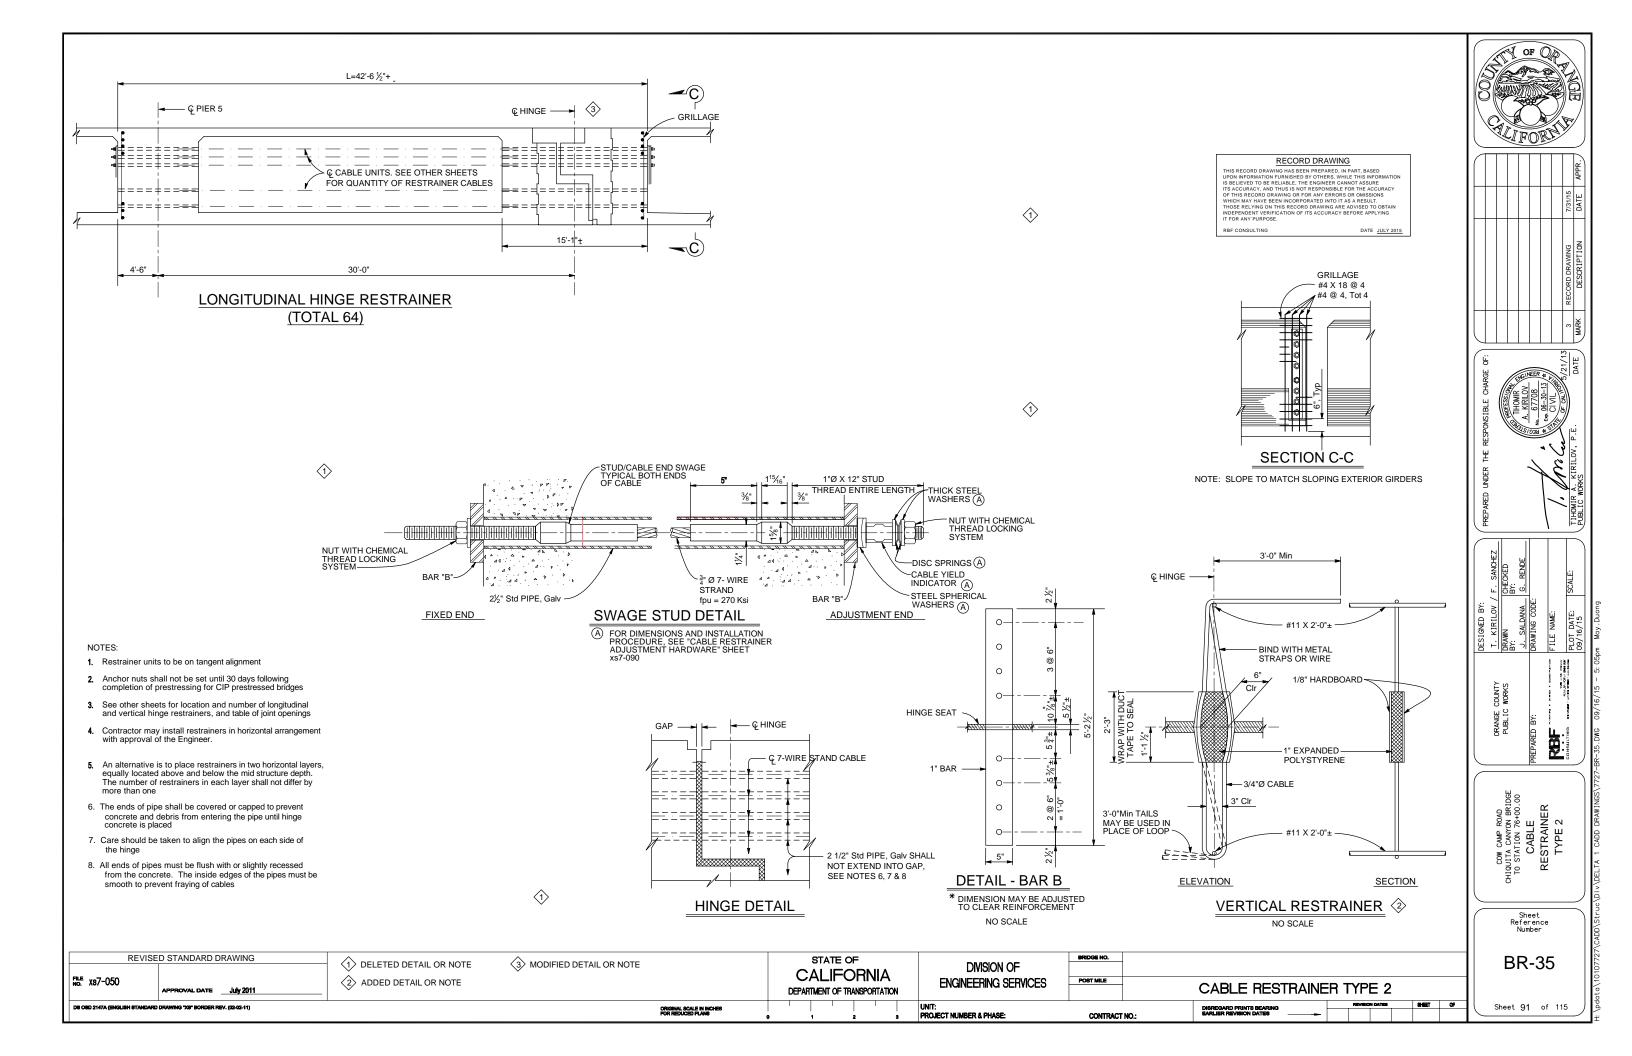
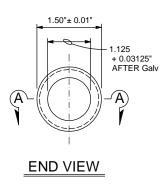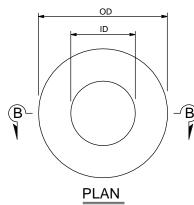
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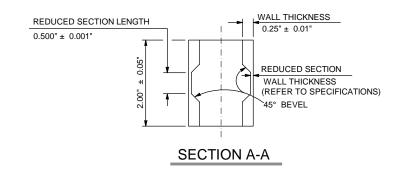
DISC SPRINGS AND WASHERS

ALL DIMENSIONS IN INCHES, EXCEPT AS NOTED


		D	ISC SPRIN	G		STEEL S	PHERICAL	WASHER	THICK WASHER			
L *	ID	OD	t	Н	COLOR CODE	ID	OD	NOMINAL THICKNESS	ID	OD	t**	
00.0 25.0	1.00	2.00	0.065	0.130	WHITE	1.19	2.25	0.50	1.03	2.00	0.25	
25.1 - 31.9	1.00	2.00	0.084	0.136	RED	1.19	2.25	0.50	1.03	2.00	0.25	
32.0 - 37.9	1.00	2.00	0.097	0.145	BLUE	1.19	2.25	0.50	1.03	2.00	0.25	
38.0 - 45.0	1.25	2.50	0.120	0.180	YELLOW	1.31	2.50	0.50	1.16	2.25	0.25	


** MINIMUM VALUE

NOTE: All OD and ID dimensions for washers and disc springs shall meet the dimensional tolerances for hardened steel washers, ASTM F436



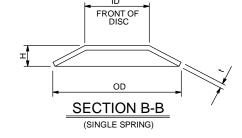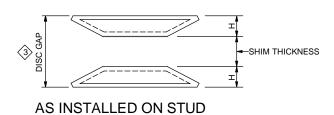"ALL DIMENSIONS ARE BEFORE GALVANIZING EXCEPT AS NOTED" CABLE YIELD INDICATOR





NOTE: FOR DIMENSIONS NOT SHOWN, SEE TABLE

STRUCTURE FEMPERATURE (F)	SHIM THICKNESS	
30	0.5"	
50	1.375"	
70	2.25"	
90	3.125"	
110	4.00"	

DISC SPRING

RESTRAINER UNIT INSTALLATION PROCEDURE

1. For typical 'girder to opposite girder' or 'bent cap to girder' restrainers with one adjustment end:

Place nut, washer and Thread Locking System on fixed end stud prior to tightening the cable

The adjustment end shall be at the same end of the cable for all restrainers at a specific hinge or bent

- Tighten the nuts on the cable from the Adjustment End of restrainer until the disc springs collapse and there is no disc gap remaining between the discs
- Place thread locking system on adjustment end(s) after tightening the cable but before backing off the nut(s)

Back off the nut(s) at the adjustable anchorage(s) a distance equal to the maximum additional amount that the hinge is expected to open, relative to existing ambient conditions, as shown on the plans for movement rating

RECORD DRAWING

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STANDARD DRAWING STATE OF 1 DELETED DETAIL OR NOTE 3 MODIFIED DETAIL OR NOTE DIVISION OF **CALIFORNIA** FILE X87-090 2 ADDED DETAIL OR NOTE **ENGINEERING SERVICES** POST MILE CABLE RESTRAINER ADJUSTMENT HARDWARE DEPARTMENT OF TRANSPORTATION APPROVAL DATE July 2011 ORIGINAL SCALE IN INCHES FOR REDUCED PLANS UNIT: PROJECT NUMBER & PHASE: DISREGARD PRINTS BEARING EARLIER REVISION DATES CONTRACT NO .:







	DESIGNED BY:	
ORANGE COUNTY	T. KIRILOV / F. SANCHEZ	F. SANCHEZ
PUBLIC WORKS	DRAWN BY:	CHECKED BY:
	J. SALDANA	G. RENDE
REPARED BY:	DRAWING CODE:	
MOTOR OFFICE OFFI	FILE NAME:	
ONSULTING SEWERS - PROCESSES - AN RECEIPED	PLOT DATE: 09/16/15	SCALE:

BR-36

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SOUTHERLY DECK OVERHANG AT HINGE

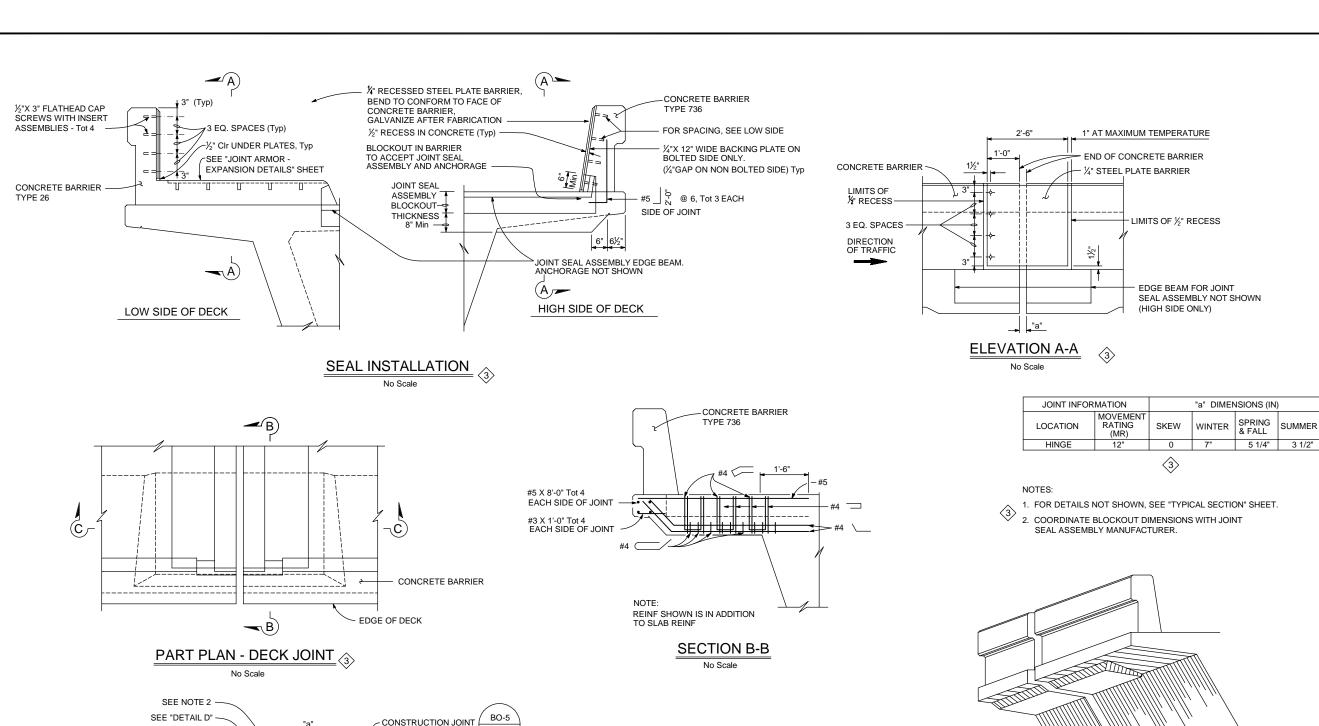No Scale
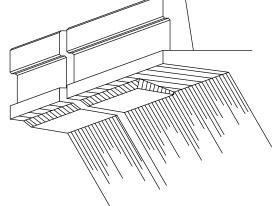
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REVISED STANDARD DRAWING STATE OF JOINT SEAL - HINGE DETAILS 1 DELETED DETAIL OR NOTE 3 MODIFIED DETAIL OR NOTE DIVISION OF **CALIFORNIA** FILE xs8-020 POST MILE 2 ADDED DETAIL OR NOTE **ENGINEERING SERVICES** MOVEMENT RATING GREATER THAN 4" DEPARTMENT OF TRANSPORTATION PROVAL DATE July 2011 UNIT: PROJECT NUMBER & PHASE: ORIGINAL SCALE IN INCHES FOR REDUCED PLANS CONTRACT NO .:

DETAIL D

No Scale

1½" Clr

1½" x 6" KEY IN OVERHANG

INDICATES JOINT SEAL ASSEMBLY BLOCKOUT

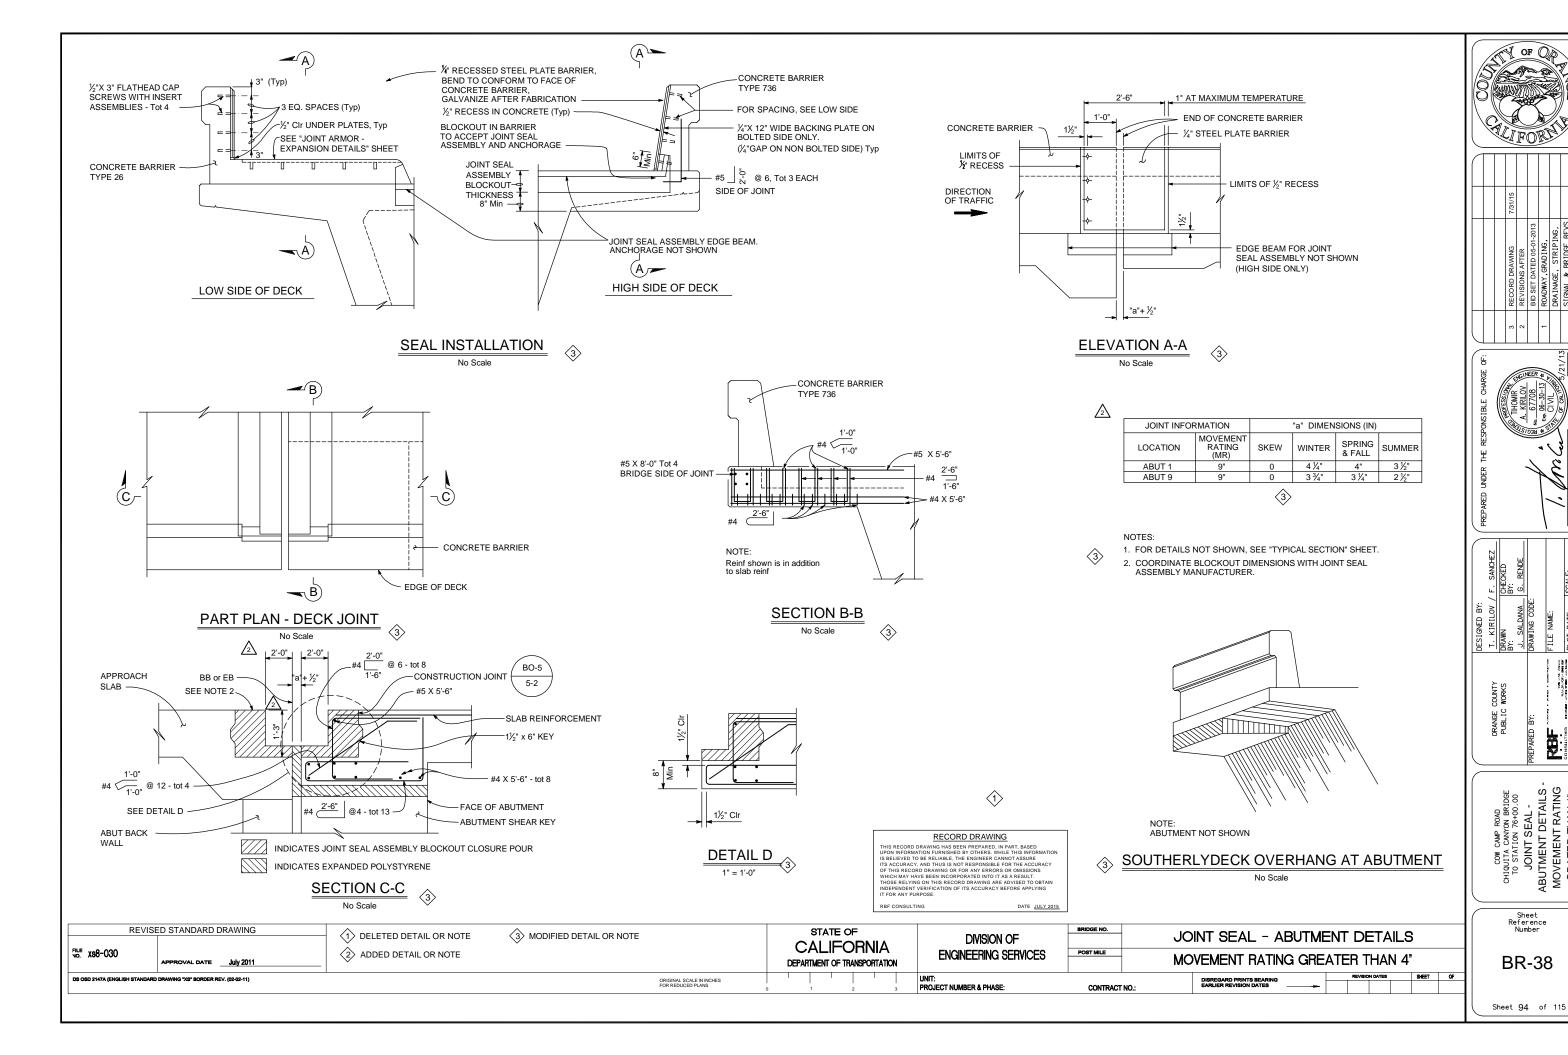
SECTION C-C

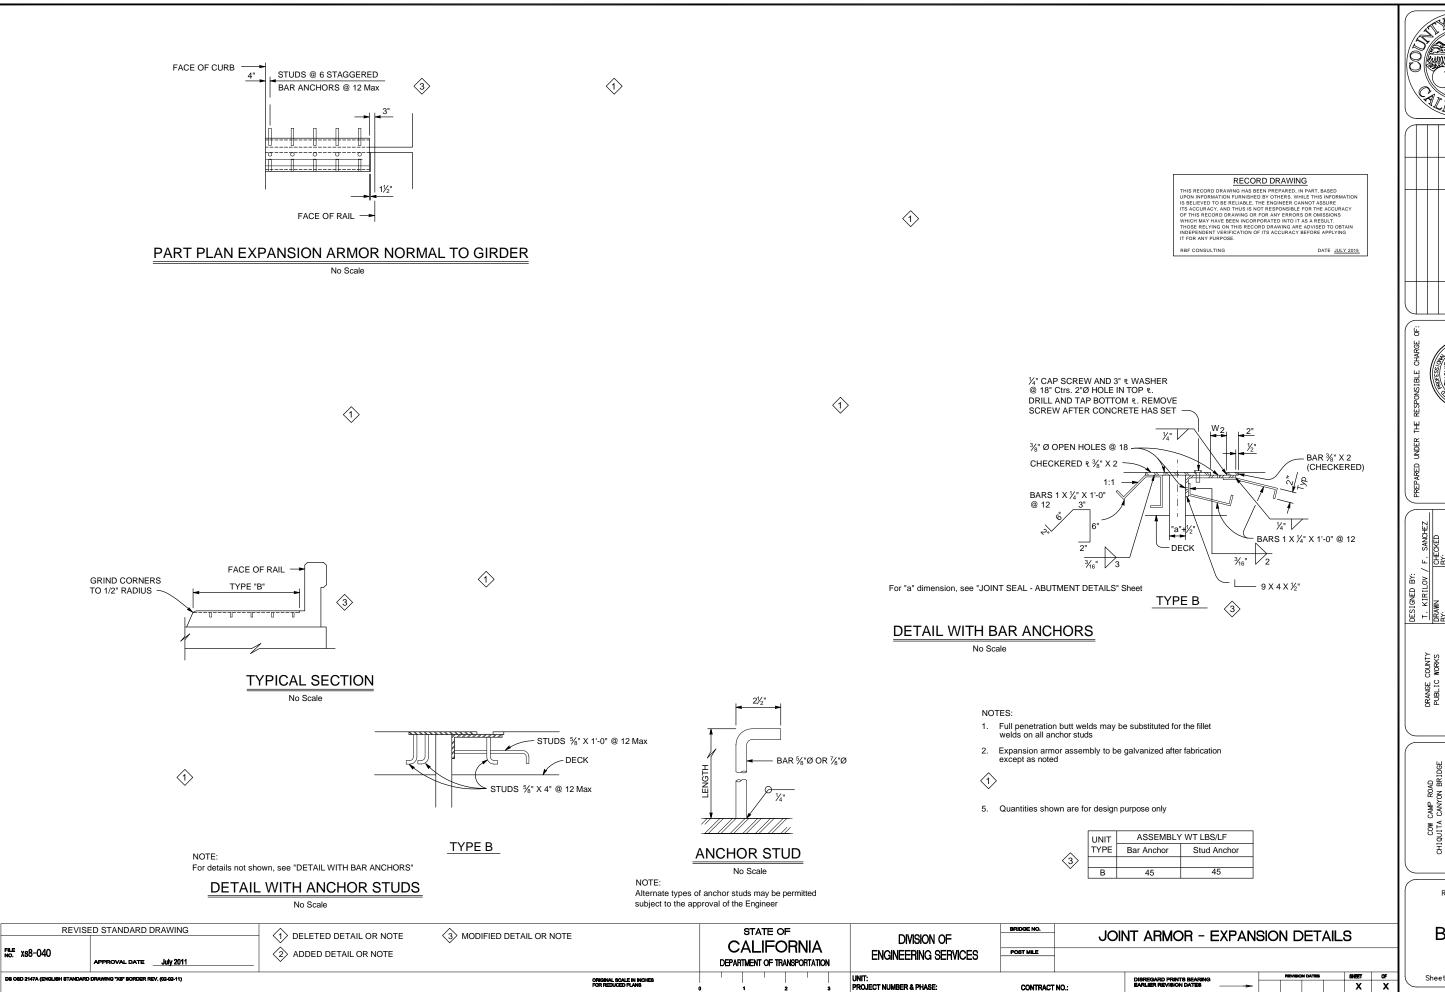
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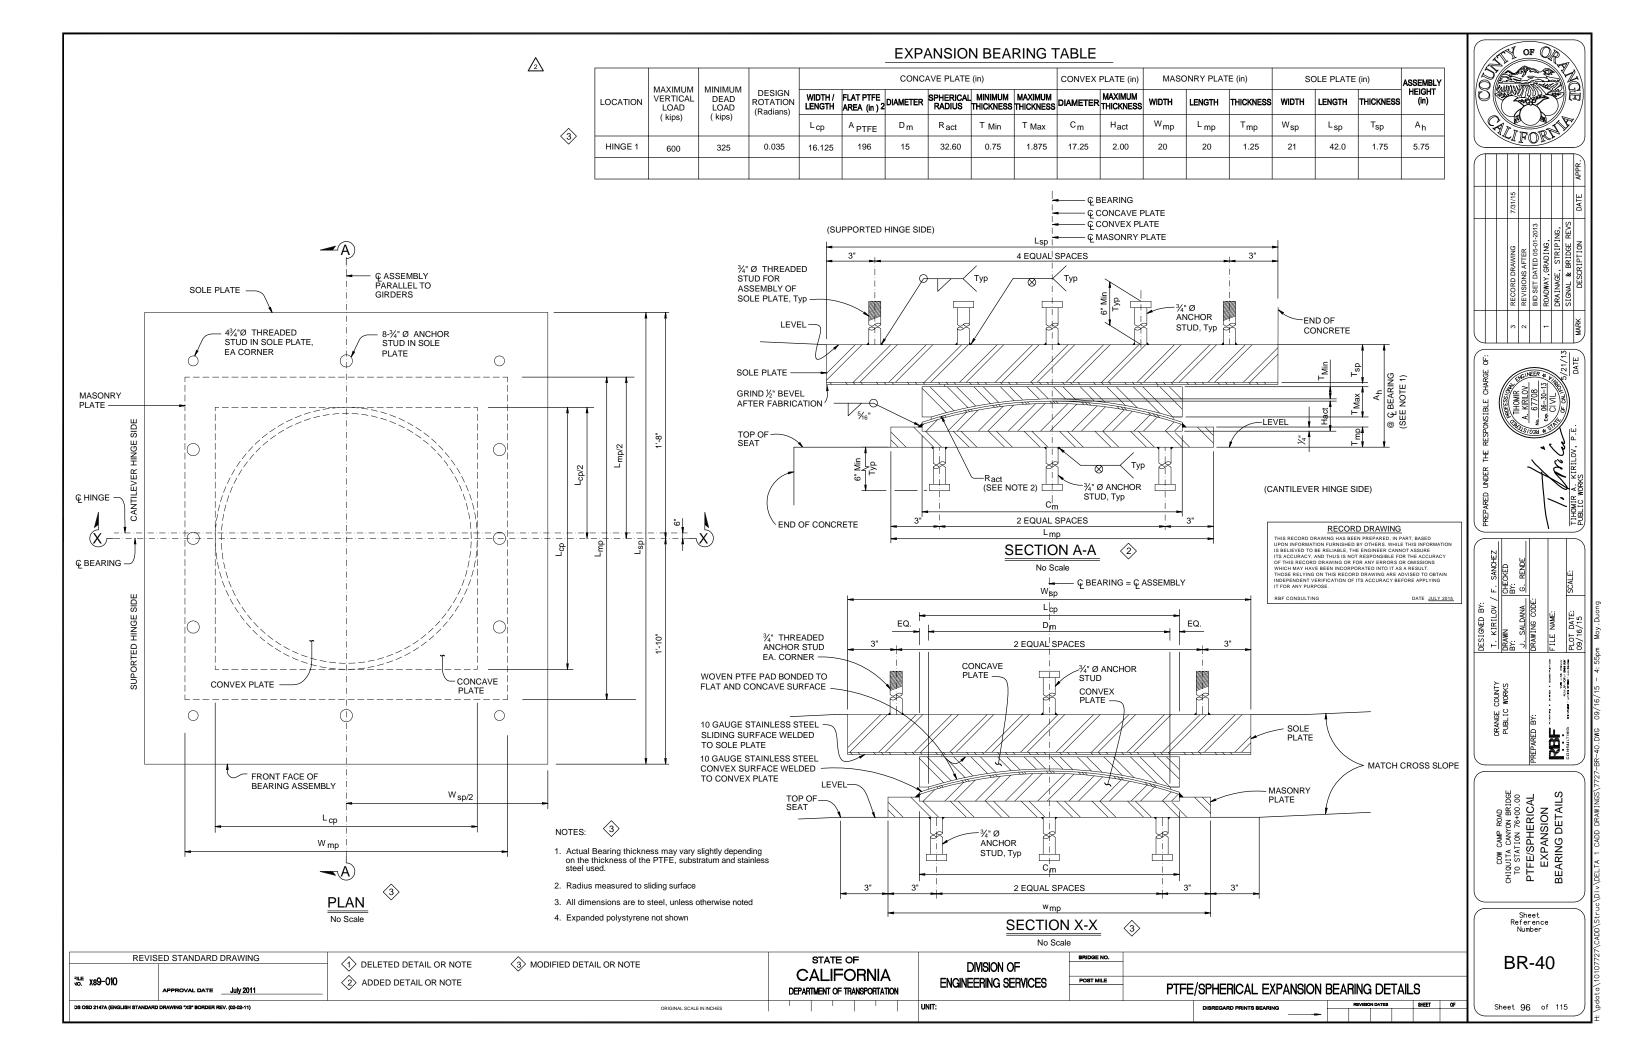





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Sheet 95 of 115






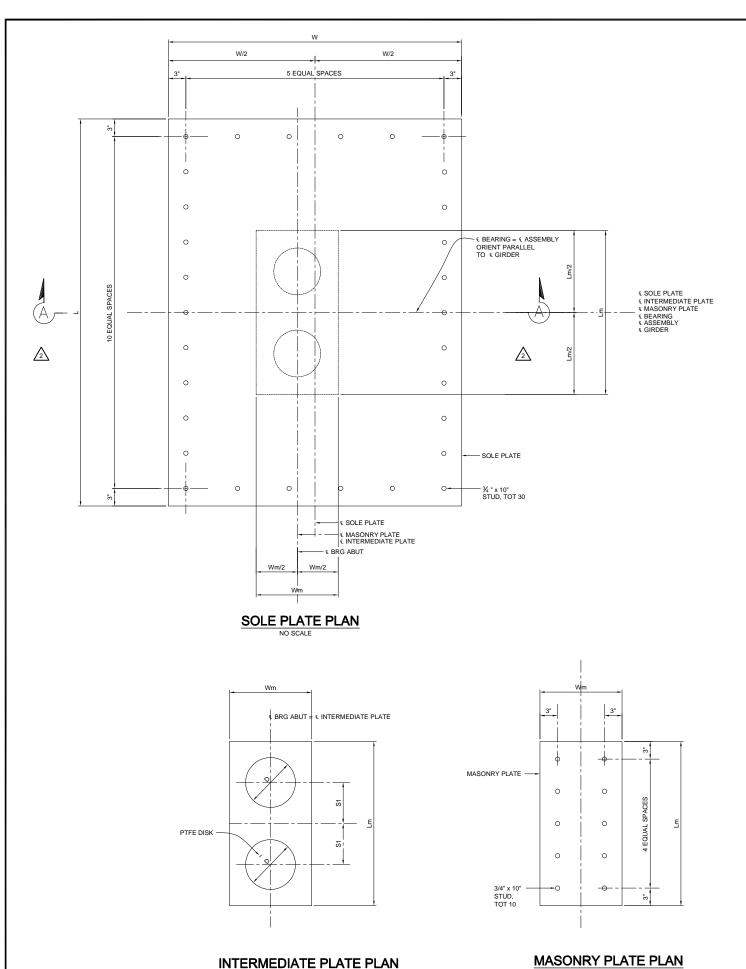SCALE: 1 ½ " = 1'-0"

	LOCATION	so	LE PLA	TE	INTERM	MEDIATE (NOTE 1)		MASC	NRY P	LATE	BEARING PAD (NOTES 1 & 2)	NUMBER OF	MAX VERT LOAD *	MIN DEAD LOAD *	
		TP	W	L	T1	S1 D Tm Wm Lm H		Н	BEARINGS	(KIPS)	(KIPS)				
	ABUT 1	4 1/1	5'-0"	5'-0"	4 1/1	7"	8"	3/=	1'-2"	2'-4"	3"	12	280	215	
ĺ	ABUT 9	1 1/4"	3-0	3-0	1 1/4"	'	0	3/4"	1 -2	2-4	3	12	200	215	

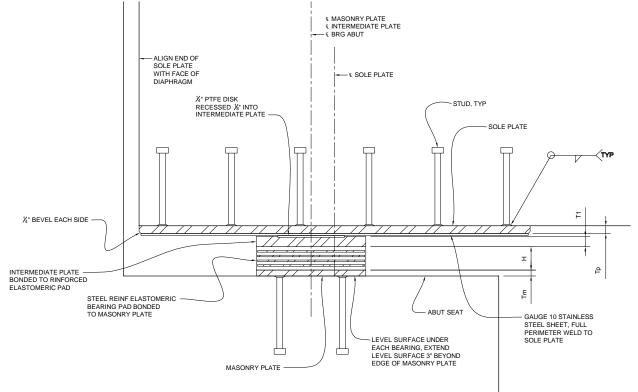* PER BEARING



SECTION A-A

RECORD DRAWING

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DATE JULY 2015

BF CONSULTING

SCALE: 1 ½ " = 1'-0"

NOTES:

- INTERMEDIATE PLATE AND ELASTOMERIC BEARING PAD PLAN DIMENSIONS SAME AS MASONRY PLATE.
- 2. ELASTOMERIC THICKNESS ONLY.
- 3. ALL DIMENSIONS ARE IN INCH UNLESS OTHERWISE SHOWN.
- 4. EXPANDED POLYSTYRENE NOT SHOWN.



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								/ BPPR. /
		7/31/15						DATE
		RECORD DRAWING	REVISIONS AFTER	BID SET DATED 05-01-2013	ROADWAY, GRADING,	DRAINAGE, STRIPING,	SIGNAL & BRIDGE REVS	DESCRIPTION
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T. KIRILOV / F. SANCHEZ	DRAWN BY:	J. SALDANA	DRAWING CODE:		FILE NAME:		PI OT DATE.
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PREPARED BY:

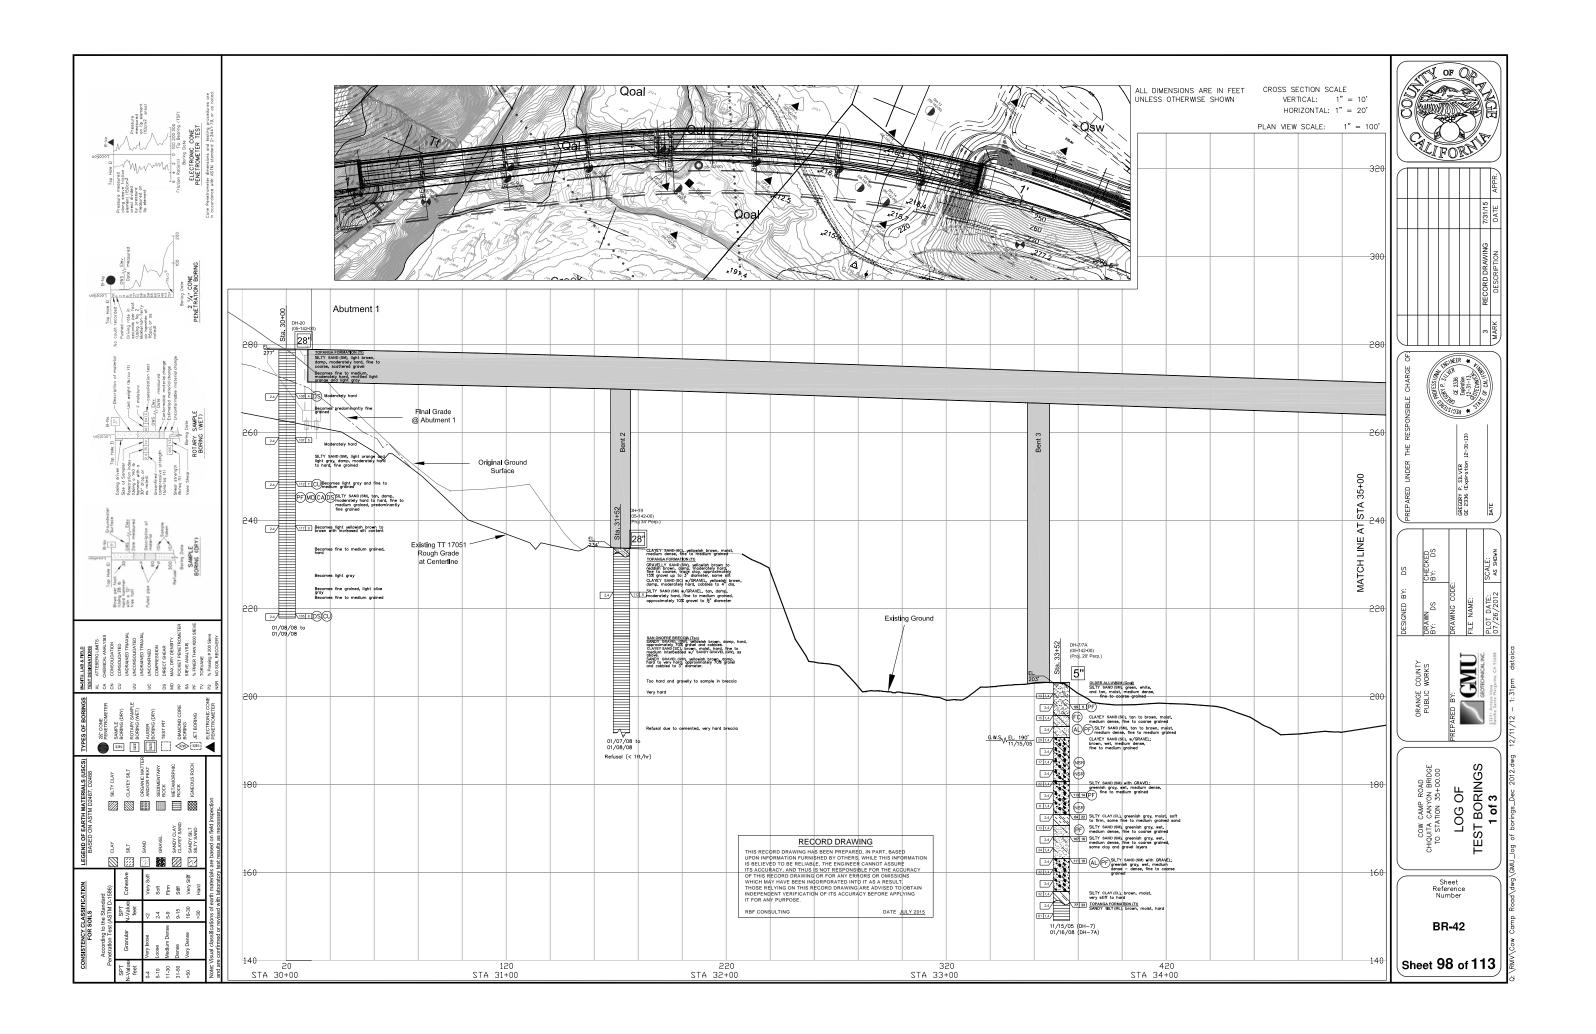
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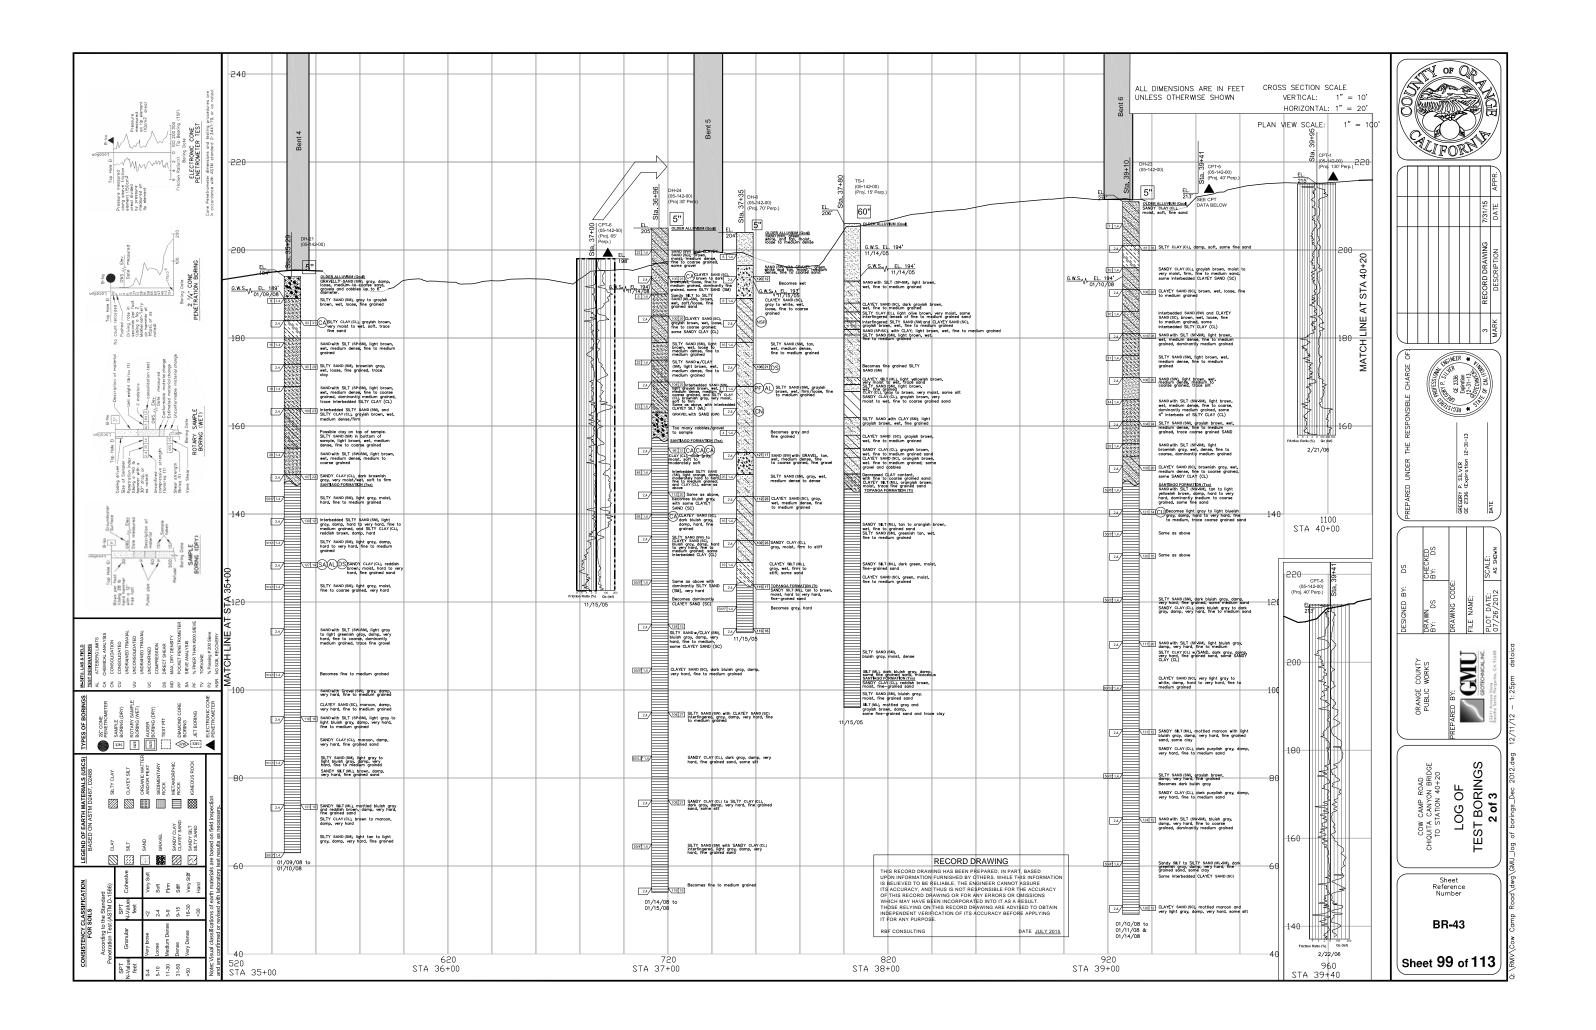
COW CAMP ROAD
CHIQUITA CANYON BRIDGE
TO STATION 76+00.00
PTFE/FLASTOMERIC
BEARING DETAILS


Sheet Reference Number
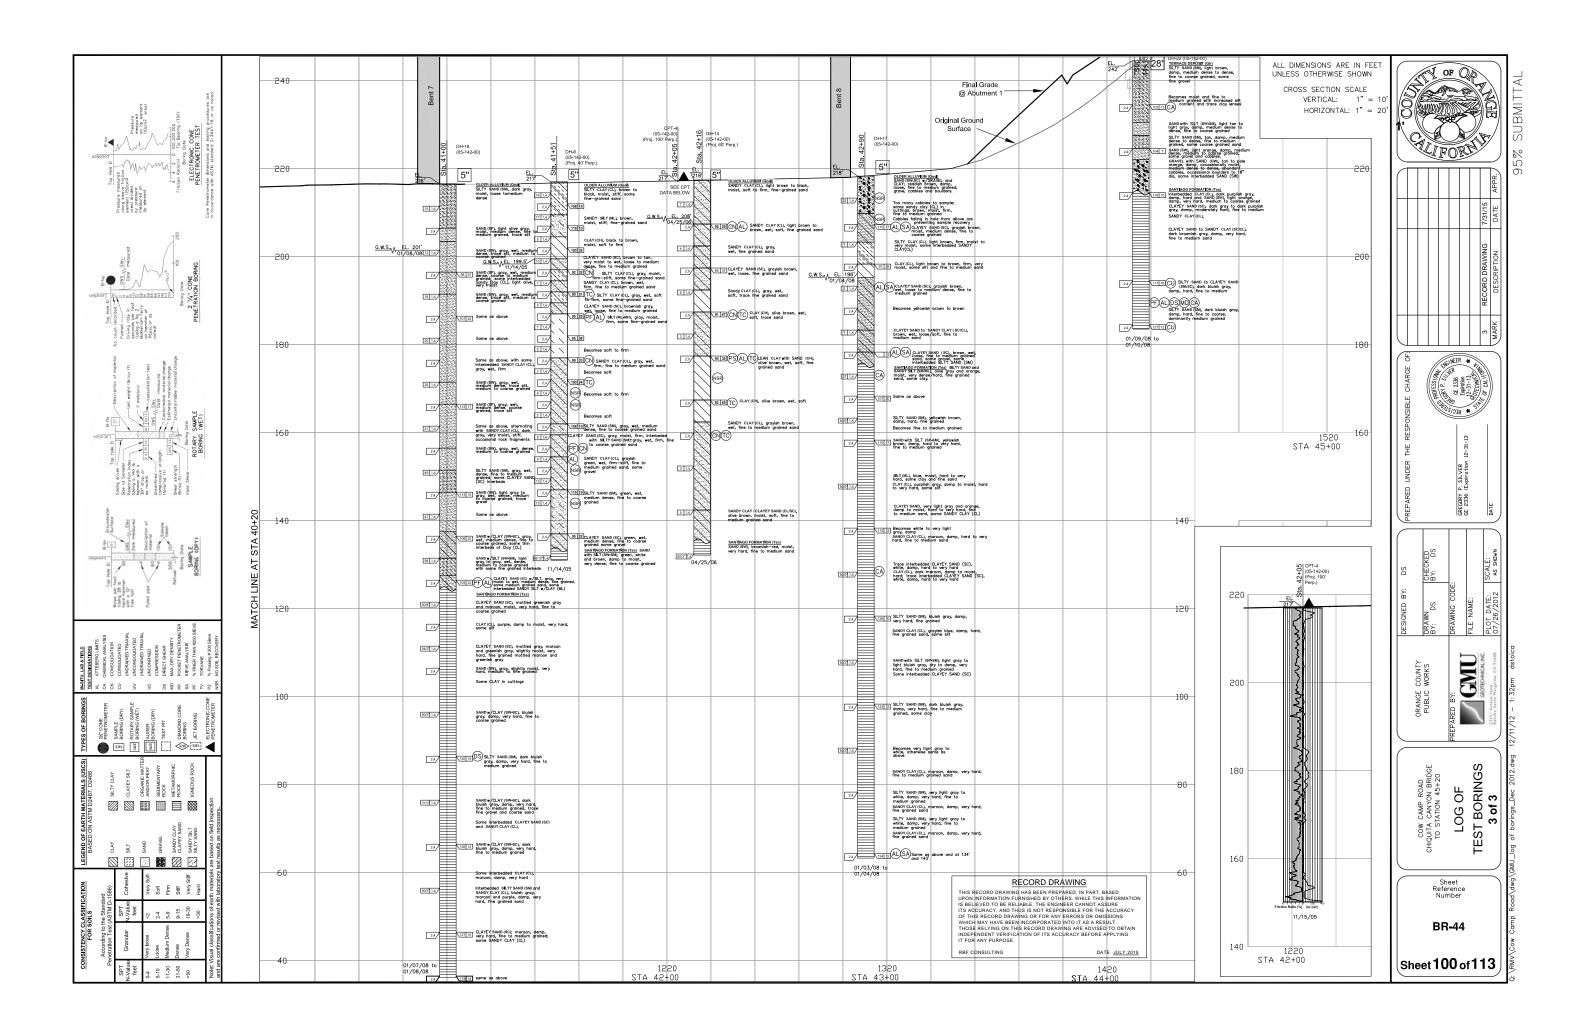
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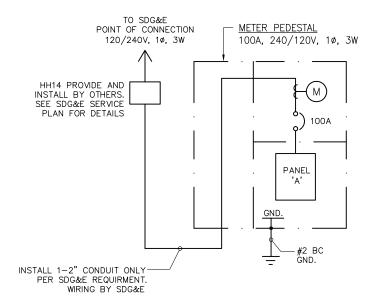






ELECTRICAL GENERAL NOTES

- ALL WRING DESIGN IS BASED ON 75 DEGREE C CONDITIONS FOR COPPER CONDUCTORS OF TYPE THWN UNLESS OTHERWISE STATED.
- ELECTRICAL CONTRACTOR TO SIZE ALL WIRING NOT EXPLICITLY SHOWN ON DRAWINGS ACCORDING TO THE REQUIREMENTS OF NATIONAL ELECTRICAL CODE (NEC) FOR THE SPECIFIC APPLICATION AND CONDITIONS.
- 3. ALL CONDUCTORS SHALL BE COPPER (MINIMUM SIZE #10 AWG UNLESS SPECIFICALLY NOTED OTHERWISE).
- 4. ALL INDICATIONS OF NUMBER OF CONDUCTORS EXCLUDE GREEN WIRE GROUND CONDUCTOR WHICH MUST BE PROVIDED.
- THE ELECTRICAL CONTRACTOR SHALL BE RESPONSIBLE TO CONFORM TO ALL LOCAL CODES AND ORDINANCES, THE STATE OF CALIFORNIA ELECTRICAL SAFETY ORDERS, THE NATIONAL ELECTRICAL CODE AND ANY ADDITIONAL JURISDICTION RELATING TO THE WORK.
- THE ELECTRICAL CONTRACTOR SHALL PROVIDE SEISMIC ANCHORAGE FOR ALL ELECTRICAL EQUIPMENT IN ACCORDANCE WITH CBC SECTION 1630 2
- 7. THE ELECTRICAL CONTRACTOR SHALL FURNISH AND INSTALL ALL POLES, FIXTURES, CONDUIT, WIRE, AND PULLBOXES REQUIRED FOR A COMPLETE AND OPERATIONAL ELECTRICAL SYSTEM.
- 8. IN THE EVENT OF A CONFLICT OR INCONSISTENCY BETWEEN ITEMS INDICATED ON THE PLANS OR WITH CODE REQUIREMENTS, THE NOTE, SPECIFICATION OR CODE WHICH PRESCRIBES AND ESTABLISHES THE MORE COMPLETE JOB OR HIGHER STANDARD SHALL PREVAIL.
- 9. ALL ELECTRICAL EQUIPMENT EXPOSED TO THE CLIMATE SHALL BE WEATHERPROOF
- 10. CONDUIT SHALL BE PER CALTRANS STANDARD SPECIFICATION SECTION 86-2.05.
- 11. THE ELECTRICAL CONTRACTOR SHALL BE RESPONSIBLE FOR LOCATING EXISTING UNDERGROUND FACILITIES AND PROTECTING THESE FACILITIES FROM DAMAGE.
- 12. THE ELECTRICAL CONTRACTOR SHALL ROUTE CONDUITS AS REQUIRED PER FIELD CONDITIONS AND C.E.C.
- 13. THE ELECTRICAL CONTRACTOR SHALL BE RESPONSIBLE FOR REPAIRING ANY DAMAGE TO EXISTING UNDERGROUND FACILITIES.
- 14. ALL ELECTRICAL EQUIPMENT IN THIS PROJECT SHALL BE U.L. LISTED.
- 15. STREET LIGHT CONTRACTOR SHALL SUBMIT "AS BUILT" UNDERGROUND WIRING PLANS TO THE OWNER.
- 16. LIGHT FIXTURE LOCATIONS PULLBOXES AND CONDUIT RUNS ARE DIAGRAMMATIC.
- 17. ALL CONDUIT ONLY INSTALLATIONS SHALL INCLUDE 1/4" PULL ROPE.
- 18. CONTRACTOR SHALL PROVIDE SUBMITTALS FOR LIGHTING FIXTURES, POLES, PULLBOXES, WIRING, AND METERED PEDESTAL. FOR APPROVAL PRIOR TO INSTALLATION.



SINGLE LINE DIAGRAM

NOTE: SINGLE LINE DIAGRAM SHOWN DIAGRAMMATIC ONLY. REFER TO CALTRANS STANDARD PLAN ES-2E FOR DETAILS.

PANELBOARD SCHEDULE

VOLTS <u>120/24</u> PHASE <u>1</u> WIRE <u>3</u>	_				EL ATION										BUS	MAIN BREAKER: BUS RATING: MOUNTING:		R:	100A 100A PEDESTAL
DESCRIPTION	LTS	REC	MIS	VOLT ØA	AMPS ØB	BRK AMP	R P	CIR	BU	N S	CIR	BRK AMP	R	VOLT ØA	AMPS ØB	LTS	REC	MIS	DESCRIPTION
** BRIDGE LIGHTS	Х			600		30	2/	1	+	\vdash	2	20	1	150					BRIDGE LIGHTS
** BRIDGE LIGHTS	Х				600	30	þ	3	Ι.	L	4	20	1						SPARE
SPARE	Х					20	1	5	+	L	6	20	1						SPARE
SPARE	Х					20	1	7	-	\perp	8	20	1						SPARE
SUBTOTAL LOAD ØA_	750)	øB.		600 0	-								150	_0_	-			
LCL X .25 _	_			_					PAN	EL	ТОТ	AL	-	135	0	VOLT	AMF	PS =_	5.63 AMPS@240V
TOTAL _	750)		60	0				HIG	Н	LEG	- ø	-	75	0	VOLT	AMF	PS =_	6.25 AMPS@120V

** COMMON NEUTRAL CIRCUIT

RECORD DRAWING

THIS RECORD DRAWING HAS BEEN PREPARED, IN PART, BASED UPON INFORMATION FURNISHED BY OTHERS. WHILE THIS INFORMATION IS BELIEVED TO BE RELIABLE, THE ENGINEER CANNOT ASSURE ITS ACCURACY, AND THUS IS NOT RESPONSIBLE FOR THE ACCURACY OF THIS RECORD DRAWING OR FOR ANY ERRORS OR OMISSIONS WHICH MAY HAVE BEEN INCORPORATED INTO IT AS A RESULT. THOSE RELYING ON THIS RECORD DRAWING ARE ADVISED TO OBTAIN INDEPENDENT VERIFICATION OF ITS ACCURACY BEFORE APPLYING IT FOR ANY PURPOSE.

RBF CONSULTING DATE JULY 2015







ANGE COUNTY

Y.P. SEE

BR:

Y.P. SEE

R. TIJERINA

BY:

BY:

BR:

DRAWING CODE:

FILE NAME:

PLOT DATE:

SCALE:

CHIQUIA CANION BRIDGE
TO STATION 76+00.00


ELECTRICAL DETAILS
1 OF 2

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DD\Elect\Dlv\Phase 1B\7727-BR-45.dwq 09/



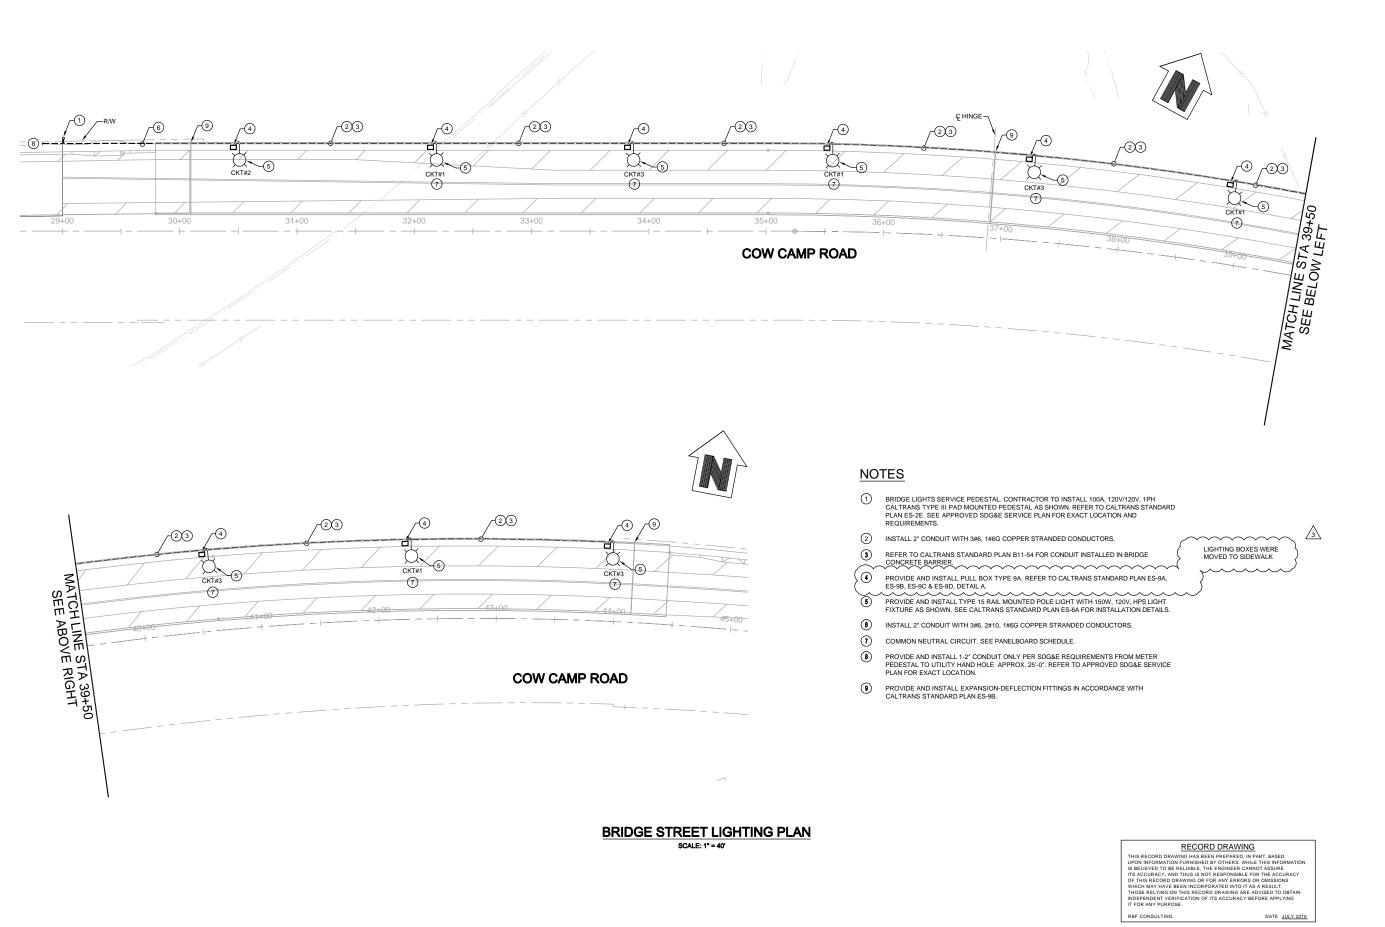COW CAMP ROAD
CHIQUITA CANYON BRIDGE
TO STATION 76+00.00
ELECTRICAL DETAILS
2 OF 2

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